

North Liberty Planning Commission

Meeting Information

Tuesday, May 7, 2019 6:30 PM City Council Chambers

If you would like additional information, larger-scale maps, or other information before the meeting, please contact Dean Wheatley at 626-5747 or at dwheatley@northlibertyiowa.org




NORTH LIBERTY PLANNING COMMISSION MEETING NOTICE AND AGENDA

Tuesday, May 7, 2019, 6:30 PM North Liberty City Council Chambers, 1 Quail Creek Circle

- 1. ROLL CALL
- 2. AGENDA APPROVAL
- SITE PLAN: Request of Penn Street Group LLC to approve a commercial site plan for Lot 10 of Liberty Centre, Part One, located on Community Drive west of Ranshaw Way/965.
 - a. Staff Presentation
 - b. Applicants Presentation
 - c. Public Comments
 - d. Questions and Comments
 - e. Recommendation to the City Council
- 4. APPROVAL OF PREVIOUS MINUTES
- 5. OLD BUSINESS
- 6. NEW BUSINESS
- 7. ADJOURNMENT

Agenda version: 5/2/2019

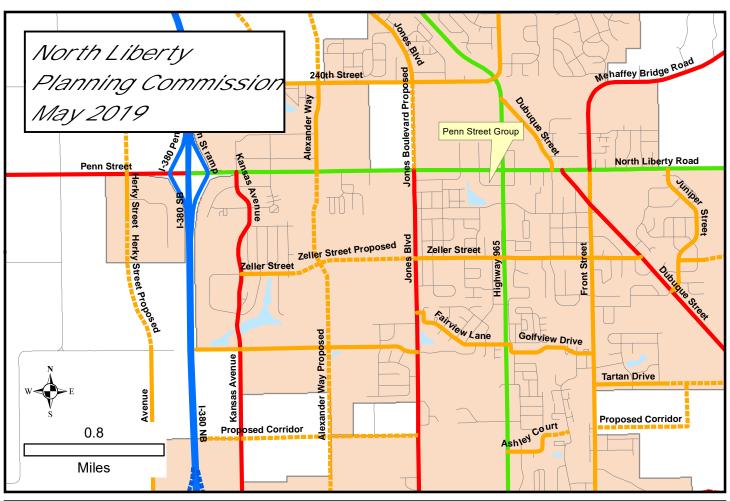





May 2, 2019

Memo

To: North Liberty Planning Commission From: Dean Wheatley, Planning Director Subject: Site Plan Approval Request (Lot 10 Liberty Centre Part One)

Your North Liberty city staff has reviewed the subject submission, and offer comments presented in this memo. The staff review team includes the following personnel:
Ryan Heiar, City Administrator
Tracey Mulcahey, Assistant City Administrator
Tom Palmer, City Building Official
Kevin Trom, City Engineer
Dean Wheatley, Planning Director

This request of Penn Street Group LLC to approve a commercial site plan located on Community Drive west of Ranshaw Way/965.

The site layout is straightforward, with ample parking (21 required, 54 provided) and good vehicular circulation. Landscape planning and pedestrian accommodations are complete. The entire frontage is lined with parking, but is set back about 20 feet from the sidewalk, with landscaping in that 20 foot area.

The building is a clean modern design that meets general design standards. HVAC equipment is on the roof, screened behind parapet walls.

A number of code and aesthetic issues have been addressed by the applicant during the staff review process, including:

- Building façade improvements.
- Pedestrian access requirements addressed.
- Pedestrian feature added.
- Parking lot screening enhanced.
- Other technical details refined.

Staff recommends approval of the site plan.


(103)-

SITE PLAN LIBERTY CENTRE - PART ONE, LOT 10 NORTH LIBERTY, IOWA

PLAT PREPARED BY: MMS CONSULTANTS INC. 1917 S. GILBERT STREET IOWA CITY, IA 52240

OWNER'S INFORMATION: PENN STREET GROUP, LLC 1700 S. 1ST AVENUE #24 IOWA CITY, IA 52240

PENN STREET GROUP, LLC 1700 S. 1ST AVENUE #24 IOWA CITY, IA 52240

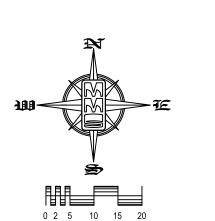

GRAPHIC SCALE IN FEET

1"=20'

<u>LEGAL DESCRIPTION</u>
LOT 10, LIBERTY CENTRE — PART ONE, NORTH LIBERTY, IOWA, IN ACCORDANCE WITH THE PLAT THEREOF RECORDED IN PLAT BOOK 47, AT PAGE 107, IN THE RECORDS OF THE JOHNSON COUNTY RECORDER'S OFFICE, CONTAINING 1.59 ACRES, AND SUBJECT TO EASEMENTS AND RESTRICTIONS OF

325.42'

- 1 SITE LAYOUT AND DIMENSION PLAN 2 SITE GRADING PLAN AND SWPPP
- 4 SITE LANDSCAPE PLAN
- 5 GENERAL NOTES AND DETAILS

BUILDING STOOP-

PER ARCHITECTURAL PLAN

SHEET INDEX

3 SITE UTILITY PLAN

PARKING CALCULATIONS 1 SPACE / 3.5 SEATS IN ASSEMBLY (24 STUDENTS) 7 SPACES 1 SPACE / FACULTY MEMBER (14 STAFF)
TOTAL REQUIRED

NOTES:
APPLICANT: PENN STREET GROUP, LLC
1700 S. 1ST AVENUE #24

1. REQUESTED LAND USE: COMMERCIAL

3. LOT 1 AREA: 69,233 SF (1.59 ACRES)

MINIMUM LOT FRONTAGE

FRONT 25 FEET

TOTAL LOT AREA

TOTAL OPEN SPACE

MAXIMUM BUILDING HEIGHT

10 FEET

PROPOSED LOT 10 COVERAGES

TOTAL NEW PAVING COVERAGE

TOTAL IMPERVIOUS COVERAGE

TOTAL EXISTING PAVING COVERAGE 8,983 SF

TOTAL BUILDING COVERAGE

LOT SETBACKS AND MINIMUM REQUIREMENTS: MINIMUM LOT WIDTH 35 FEET

IOWA CITY, IA 52240

2. EXISTING ZONING: C-2-A (HIGHWAY COMMERCIAL DISTRICT)

35 FEET

SIDE REAR

35 FEET OR 2.5 STORIES

5 FEET

(13.0%)

(71.2%)

(28.8%)

-*----*---

FRONT 10 FEET SIDE 5 FEET

12,333 SF

27,972 SF

49,288 SF

19,945 SF

TOTAL PROVIDED 51 REGULAR SPACES VAN SPACES 2 ADA SPACES
TOTAL 54 SPACES

- EXISTING EVERGREEN TREES & SHRUBS THE ACTUAL SIZE AND LOCATION OF ALL PROPOSED FACILITIES SHALL BE VERIFIED WITH CONSTRUCTION DOCUMENTS. WHICH ARE TO BE PREPARED AND SUBMITTED SUBSEQUENT TO THE

STANDARD LEGEND AND NOTES

- — — — — — PROPOSED EASEMENT LINES ----- EXISTING EASEMENT LINES

---- - RIGHT-OF-WAY LINES

-PROP-

— — — — — CONGRESSIONAL SECTION LINES

- --- - - EXISTING RIGHT-OF-WAY LINES

EXISTING CENTER LINES

- LOT LINES, INTERNAL

- RECORDED DIMENSIONS - CURVE SEGMENT NUMBER

- POWER POLE W/DROP

- SANITARY MANHOLE

- DRAINAGE MANHOLE

EXISTING SANITARY SEWER PROPOSED SANITARY SEWER

EXISTING STORM SEWER

- PROPOSED STORM SEWER

- - CONTOUR LINES (1' INTERVAL)

- POWER POLE W/TRANS - POWER POLE W/LIGHT

- - CENTER LINES

BENCHMARK

POWER POLE

GUY POLE

FIRE HYDRANT

WATER VALVE

CURB INLET

- FENCE LINE

WATER LINES

GAS LINES

- ELECTRICAL LINES - TELEPHONE LINES

 EXISTING TREE LINE - EXISTING DECIDUOUS TREE & SHRUB

- - PROPERTY &/or BOUNDARY LINES

- LOT LINES, PLATTED OR BY DEED

COMPLETE CONTRACTOR IMPROVEMENTS (INCLUDES WORK WITHIN RIGHT OF WAY) PCC ON 6" AGGREGATE (10,089 SI - DESIGNED TO SUPPORT THE SINGLE AXLE WEIGHT OF THE NORTH LIBERTY 75,000 LBS GROSS WEIGHT FIRE TRUCK 5" PCC ON 4" AGGREGATE(10,542 SF) 4" PCC (7,341 SF)

(THESE QUANTITIES INCLUDE ALL SITE IMPROVEMENTS) **KEYNOTES** NUMBER INSTALL DRIVE PER DETAIL (THICKNESS AND MATERIAL (102) INSTALL 6" STANDARD CURB 103 CURB TRANSITION INSTALL P.C.C. SIDEWALK PER NORTH LIBERTY MUNICIPAL DESIGN STANDARDS INSTALL ACCESSIBLE PARKING, RAMPS, STRIPING AND SIGNAGE PER DETAILS. DUMPSTER ENCLOSURE, CONNECT TO EXISTING DUMPSTER ENCLOSURE, WITH SAME MATERIALS INSTALL 4" WIDE PAVEMENT MARKINGS (TYP) INSTALL ADA COMPLIANT CURB RAMP GRIND EXISTING CURB AND INSTALL DRIVEWAY ENTRANCE (110) SAWCUT AND REMOVE PCC INSTALL DRIVEWAY PER DETAIL (SHEET 5) INSTALL CURB AND GUTTER PER DETAIL (SHEET 5) CONNECT TO EXIST SLAB WITH IDOT 'RD' JOINT INSTALL THICKENED EDGE SIDEWALK PER DETAIL (SHEET 5) CEDAR TRELLIS OVER PICNIC TABLE ON PCC PATIO, SEE RENDERING ON SHEET 4

50 GALLON RESIN DECK BOX OR APPROVED EQUAL FOR

DECORATIVE FENCE - AMERISTAR, MONTAGE PLU SERIES, MAJESTIC PANEL, 6' TALL, BLACK WITH MATCHING 5' GATES AT WALKWAYS

OUTDOOR STORAGE

LIGHT POLE, BY OTHERS

1.59 AC **CIVIL ENGINEERS** LAND PLANNERS LAND SURVEYORS LANDSCAPE ARCHITECTS

ENVIRONMENTAL SPECIALISTS

1917 S. GILBERT ST.

(319) 351-8282


IOWA CITY, IOWA 52240

www.mmsconsultants.net


Date Revision

SITE LAYOUT AND **DIMENSION PLAN**

LIBERTY CENTRE PART ONE, LOT 10 NORTH LIBERTY JOHNSON COUNTY

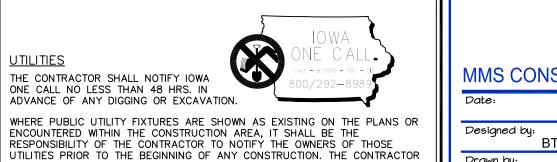

MMS CONSULTANTS, INC. 05-02-19 Field Book No: Project No: IOWA CITY 10355-003

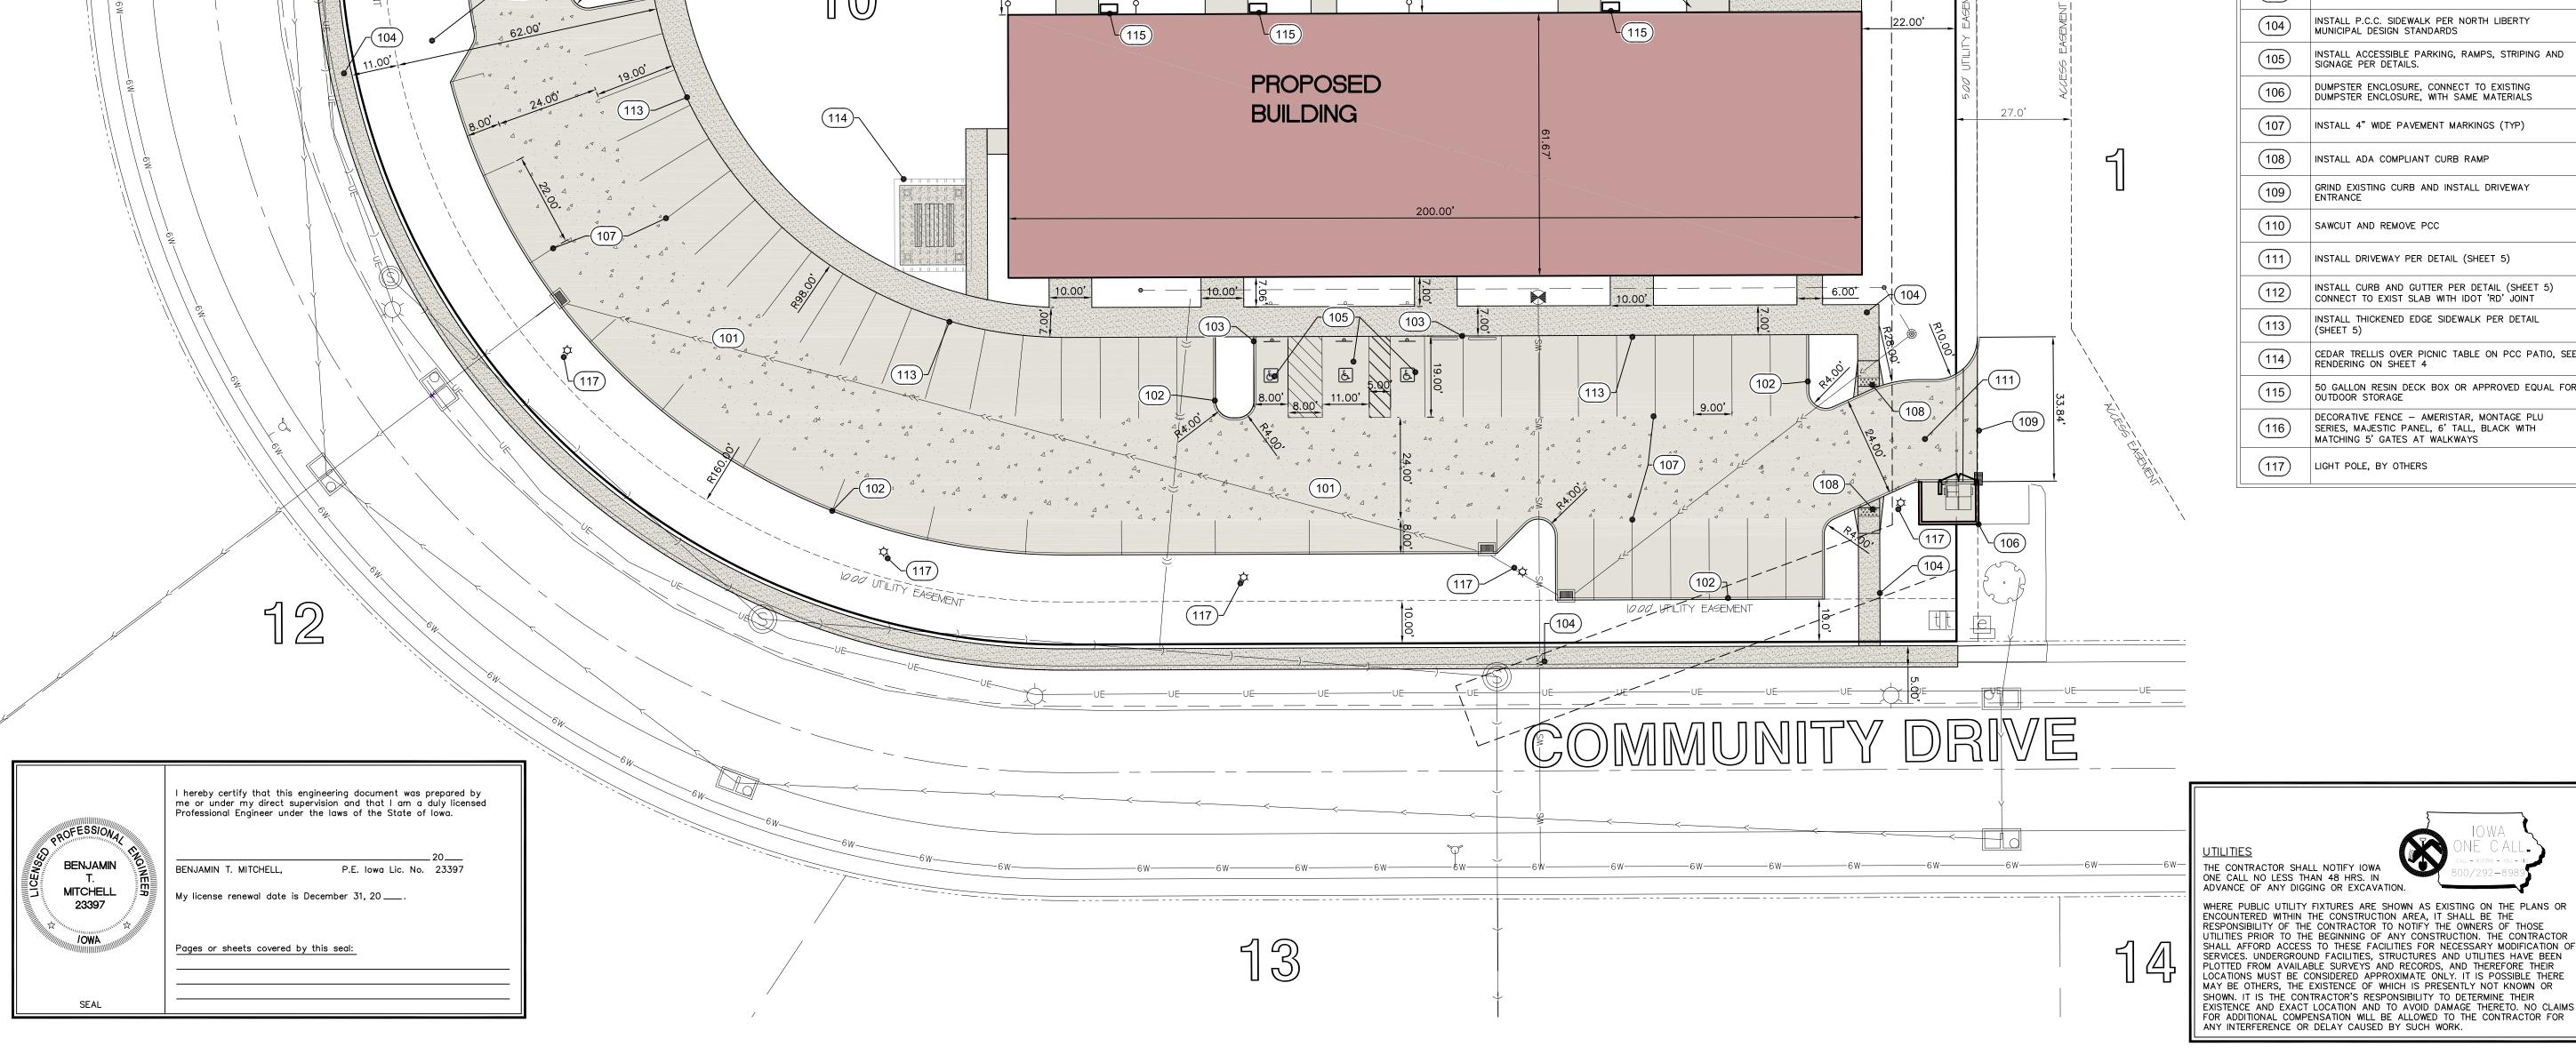

THE CONTRACTOR SHALL NOTIFY IOWA ONE CALL NO LESS THAN 48 HRS. IN ADVANCE OF ANY DIGGING OR EXCAVATION.

WHERE PUBLIC UTILITY FIXTURES ARE SHOWN AS EXISTING ON THE PLANS OR ENCOUNTERED WITHIN THE CONSTRUCTION AREA, IT SHALL BE THE RESPONSIBILITY OF THE CONTRACTOR TO NOTIFY THE OWNERS OF THOSE UTILITIES PRIOR TO THE BEGINNING OF ANY CONSTRUCTION. THE CONTRACTOR SHALL AFFORD ACCESS TO THESE FACILITIES FOR NECESSARY MODIFICATION OF SERVICES. UNDERGROUND FACILITIES, STRUCTURES AND UTILITIES HAVE BEEN PLOTTED FROM AVAILABLE SURVEYS AND RECORDS, AND THEREFORE THEIR LOCATIONS MUST BE CONSIDERED APPROXIMATE ONLY. IT IS POSSIBLE THERE MAY BE OTHERS, THE EXISTENCE OF WHICH IS PRESENTLY NOT KNOWN OR SHOWN. IT IS THE CONTRACTOR'S RESPONSIBILITY TO DETERMINE THEIR EXISTENCE AND EXACT LOCATION AND TO AVOID DAMAGE THERETO. NO CLAIMS FOR ADDITIONAL COMPENSATION WILL BE ALLOWED TO THE CONTRACTOR FOR

778.07TS

ANY INTERFERENCE OR DELAY CAUSED BY SUCH WORK.

THE CONTRACTOR SHALL PROVIDE TRAFFIC CONTROL PER IDOT STANDARD ROAD PLANS AND CITY OF NORTH LIBERTY REQUIREMENTS AT ALL TIMES DURING WORK WITHIN PUBLIC

THE CONTRACTOR SHALL COORDINATE WITH UTILITY PROVIDERS FOR ANY REQUIRED RELOCATION OF EXISTING UTILITIES.

1 SITE LAYOUT AND DIMENSION PLAN

2 SITE GRADING PLAN AND SWPPP

5 GENERAL NOTES AND DETAILS

SHEET INDEX

1.50%

779.04TC 778.54TS

3 SITE UTILITY PLAN

4 SITE LANDSCAPE PLAN

GRADING TOPSOIL NOTE: PRIOR TO FINAL SEEDING, ALL GREEN SPACE SHALL BE TILLED TO A MINIMUM DEPTH OF 12" AND COVERED WITH A MINIMUM OF 6" OF TOPSOIL. CONTRACTOR SHALL BE RESPONSIBLE FOR STOCKPILING ADEQUATE TOPSOIL FOR ALL GREEN SPACE.

GRADING AND EROSION CONTROL NOTES

TOTAL SITE AREA: 1.59 ACRES TOTAL AREA TO BE DISTURBED: 1.39 ACRES

EROSION CONTROL MEASURES SHOWN SHALL BE USED DURING FILL ACTIVITIES. EROSION CONTROL MEASURES SHALL BE REEVALUATED AND MODIFIED, IF NECESSARY, AT THE TIME OF SITE DEVELOPMENT. ADDITIONAL EROSION AND SEDIMENT CONTROL MEASURES THAT COULD BE USED ON SITE, IF NEEDED, CAN BE FOUND IN APPENDIX D OF THE STORM WATER POLLUTION PREVENTION PLAN (SWPPP) BINDER PREPARED FOR THE SITE. IF ADDITIONAL MEASURES ARE USED, INDICATE THE TYPE AND LOCATION OF SAID MEASURE ON THIS PLAN.

CONTRACTOR SHALL INSTALL A ROCK ENTRANCE AND PERFORM REGULAR CLEANING OF VEHICLES THAT LEAVE THE SITE. FOLLOWING INSTALLATION OF PERIMETER SILT FENCE AND TEMPORARY CONSTRUCTION ENTRANCE THE CONTRACTOR SHALL CONTACT THE CITY INSPECTOR TO SCHEDULE A SITE INSPECTION PRIOR TO ANY SOIL

THE CONTRACTOR SHALL FOLLOW THE NPDES PERMIT, SWPPP, AND THE CITY CSR REGULATIONS.

STABILIZATION SEEDING STABILIZATION SEEDING SHALL BE IN ACCORDANCE WITH SUDAS SECTION 9010.2.02 SEED MIXTURES AND SEEDING DATES.

COMMON NAME APPLICATION RATE lb/acre SPRING - MARCH 1 - MAY 20 ANNUAL RYEGRASS 65 SUMMER - MAY 21 - AUGUST 14 ANNUAL RYEGRASS 50 95 FALL - AUGUST 15 - SEPTEMBER 30 ANNUAL RYEGRASS 40

* ENGINEER MAY DELETE FOR PREVIOUSLY ESTABLISHED URBAN AREAS.

GRAIN RYE

TABLE 9010.06: TYPE 4 SEED MIXTURE

FERTILIZER SHALL BE APPLIED AT A RATE OF 300 LBS PER ACRE USING CHEMICALLY COMBINED COMMERCIAL 13-13-13 FERTILIZER (SUDAS SECTION 9010.2.03 A.2)

(781.61TC)

781.11TS

EROSION CONTROL LEGEND PERIMETER SILT FENCE SILT FENCE TEMPORARY ROCK CONSTRUCTION ENTRANCE/EXIT TEMPORARY SOIL STOCKPILE AREA TEMPORARY PARKING AND STORAGE \Longrightarrow DIRECTION OF OVERLAND FLOW CONCRETE TRUCK/EQUIPMENT WASHOUT DUMPSTER FOR CONSTRUCTION WASTE PORTABLE RESTROOM RIP RAP OUTLET PROTECTION DOCUMENT LOCATION (PERMITS, SWPPP, INSPECTION FORMS, ETC.) EROSION CONTROL BLANKET: NORTH AMERICAN GREEN SC150 OR APPROVED EQUIVELANT INLET PROTECTION: 1. PRIOR TO STREET PAVING: INSTALL FABRIC UNDER INTAKE GRATE. OTHER MEASURE: OTHER MEASURE: ____ OTHER MEASURE: ____ FILTER SOCK BEHIND CURB AT CURB RAMP

ALL SLOPES GREATER THAN 4:1 SHALL HAVE MATTING MEETING OR EXCEEDING SC150 APPLIED OVER SEEDED SURFACE. THE ABOVE LISTED ITEMS ARE SHOWN IN THEIR RECOMMENDED LOCATIONS. IF A CONTROL MEASURE IS ADDED OR MOVED TO A MORE SUITABLE LOCATION, INDICATE THE REVISION ON THIS SHEET. THE BLANKS LEFT FOR OTHER MEASURES SHOULD BE USED IF AN ITEM NOT SHOWN ABOVE IS IMPLEMENTED ON SITE, ADDITIONAL PRACTICES FOR EROSION PREVENTION AND SEDIMENT CONTROL CAN BE FOUND APPENDIX D OF THE SWPPP.

781.49TS

(782.60TS)

SILT FENCE DETAIL COMPACTED NATIVE SOIL BACKFILL FILTER FABRIC -- UNDISTURBED OR COMPACTED SOIL

INSTALLATION POSTS SHALL BE 1.33 POUNDS PER LINEAL FOOT STEEL WITH A MINIMUM LENGTH OF 5 FEET. STEEL POSTS SHALL HAVE PROJECTIONS FOR FASTENING WIRE TO

SILT FENCE FABRIC SHALL CONFORM TO I.D.O.T. STANDARD SPECIFICATION SECTION 4196.01.A. SILT FENCING SHALL BE A MINIMUM OF 24" AND A MAXIMUM OF 36" HIGH WHEN COMPLETE.

LENGTH OF THE FENCE TO AVOID THE USE OF JOINTS. WHEN JOINTS ARE NECESSARY, THE FILTER CLOTH SHALL BE SPLICED TOGETHER ONLY AT A SUPPORT POST, WITH A MINIMUM 6" OVERLAP, AND SECURELY SEALED. POSTS SHALL BE SPACED A MAXIMUM OF 8 FEET APART AND DRIVEN SECURELY

THE FILTER FABRIC SHALL BE PURCHASED IN A CONTINUOUS ROLL CUT TO THE

INTO THE GROUND ALONG THE FENCE ALIGNMENT. POSTS SHALL BE DRIVEN INTO THE GROUND A MINIMUM OF 28".

5. A TRENCH SHALL BE EXCAVATED APPROXIMATELY 4" WIDE BY 12" DEEP ALONG THE UPSLOPE SIDE OF THE POSTS. FILTER FABRIC SHALL BE STAPLED OR WIRED TO THE POSTS SUCH THAT THE

FABRIC EXTENDS INTO THE TRENCH AS SHOWN ABOVE. THE FABRIC SHALL BE FASTENED A MINIMUM OF THREE PLACES ON EACH POST.

THE TRENCH SHALL BE BACK FILLED WITH EXCAVATED MATERIAL AND THOROUGHLY COMPACTED.


MAINTENANCE SILT FENCES SHALL BE INSPECTED WEEKLY AND AFTER EACH RAIN-FALL EVENT OF 0.5 INCHES OR MORE. DURING PERIODS OF PROLONGED RAIN INSPECTIONS SHALL BE AT LEAST DAILY. ANY REPAIRS NEEDED TO MAINTAIN THE SILT FENCE'S EFFECTIVENESS SHALL BE MADE IMMEDIATELY.

SHOULD THE FABRIC ON A SILT FENCE DECOMPOSE OR BECOME INEFFECTIVE PRIOR TO STABILIZING THE UPSLOPE AREAS THE FABRIC SHALL BE REPLACED

SEDIMENT DEPOSITS SHOULD BE REMOVED AFTER EACH STORM EVENT. THEY MUST BE REMOVED WHEN THE DEPOSITS REACH APPROXIMATELY ONE-HALF THE HEIGHT OF THE FENCE. SILTS REMOVED SHALL BE PLACED IN A PROTECTED PLACE THAT WILL PREVENT THEIR ESCAPE FROM THE CONSTRUCTION SITE.

GRADE, PREPARED AND SEEDED. SILT FENCE SHALL REMAIN IN PLACE UNTIL IT IS NO LONGER NEEDED AS DIRECTED BY THE POLLUTION PREVENTION PLAN. GENERALLY SILT FENCES SHALL REMAIN UNTIL THE UPSLOPE AREAS ARE STABILIZED WITH AN

ANY SEDIMENT DEPOSITS REMAINING IN PLACE AFTER THE SILT FENCE IS NO LONGER NEEDED SHALL BE DRESSED TO CONFORM WITH THE EXISTING

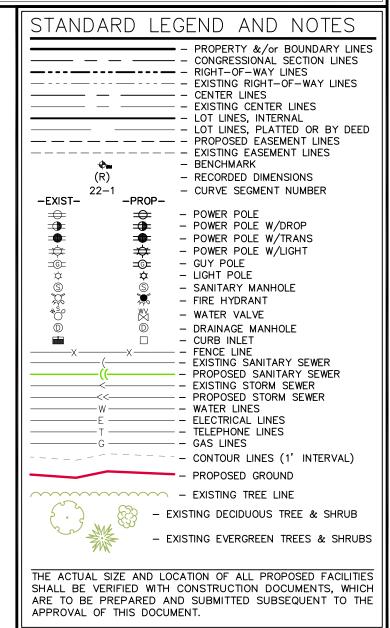

CIVIL ENGINEERS

LAND PLANNERS LAND SURVEYORS LANDSCAPE ARCHITECTS **ENVIRONMENTAL SPECIALISTS** 1917 S. GILBERT ST. IOWA CITY, IOWA 52240 (319) 351-8282 www.mmsconsultants.net

Date Revision


SITE GRADING PLAN AND SWPPP

LIBERTY CENTRE PART ONE, LOT 10 NORTH LIBERTY JOHNSON COUNTY

MMS CONSULTANTS, INC. 05-02-19 Field Book No: Drawn by: Checked by: Project No:

IOWA CITY

10355-003

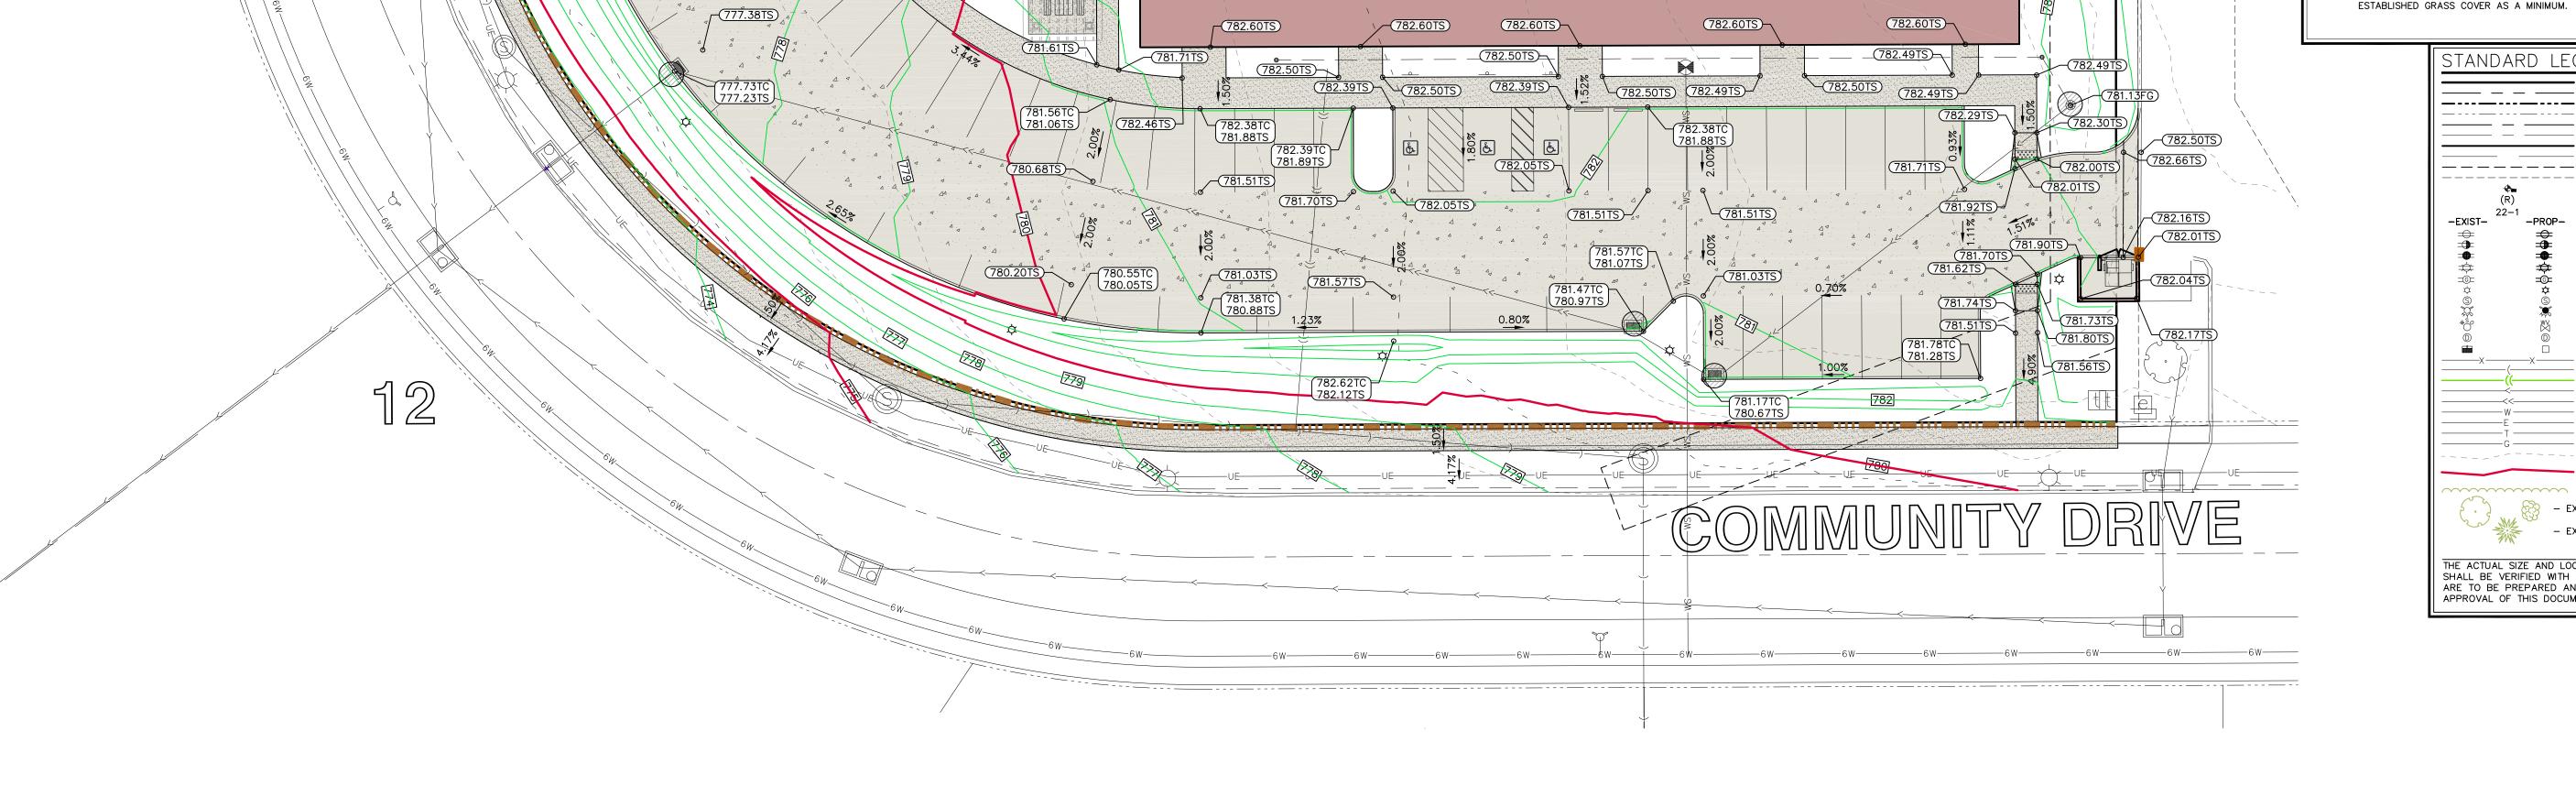

782-

-(782.60TS)

(782.45TS)-

BUILDING

F.F. = 782.64

SHEET INDEX

THE CONTRACTOR SHALL PROVIDE TRAFFIC CONTROL PER IDOT

THE CONTRACTOR SHALL COORDINATE WITH UTILITY PROVIDERS

EXISTING FIRE HYDRANT

REQUIREMENTS AT ALL TIMES DURING WORK WITHIN PUBLIC

STANDARD ROAD PLANS AND CITY OF NORTH LIBERTY

FOR ANY REQUIRED RELOCATION OF EXISTING UTILITIES.

R.O.W.

1 SITE LAYOUT AND DIMENSION PLAN

2

2 SITE GRADING PLAN AND SWPPP

3 SITE UTILITY PLAN


4 SITE LANDSCAPE PLAN 5 GENERAL NOTES AND DETAILS



CIVIL ENGINEERS LAND PLANNERS LAND SURVEYORS LANDSCAPE ARCHITECTS ENVIRONMENTAL SPECIALISTS 1917 S. GILBERT ST. IOWA CITY, IOWA 52240

(319) 351-8282 www.mmsconsultants.net

Date Revision

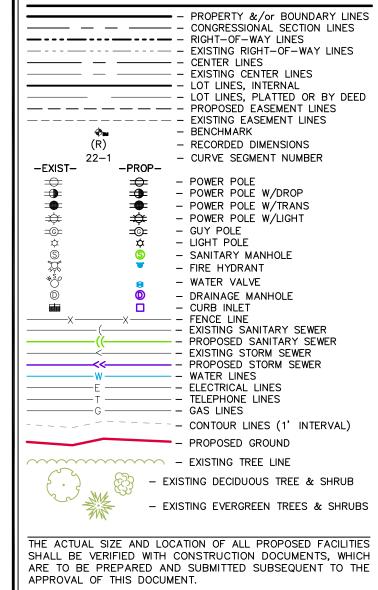

STANDARD LEGEND AND NOTES THE ACTUAL SIZE AND LOCATION OF ALL PROPOSED FACILITIES SHALL BE VERIFIED WITH CONSTRUCTION DOCUMENTS, WHICH


UTILITY PLAN

LIBERTY CENTRE PART ONE, LOT 10 NORTH LIBERTY JOHNSON COUNTY IOWA

MMS CONSULTANTS, INC. 05-02-19 Designed by: Field Book No: Drawn by: Checked by: Project No:

IOWA CITY

10355-003

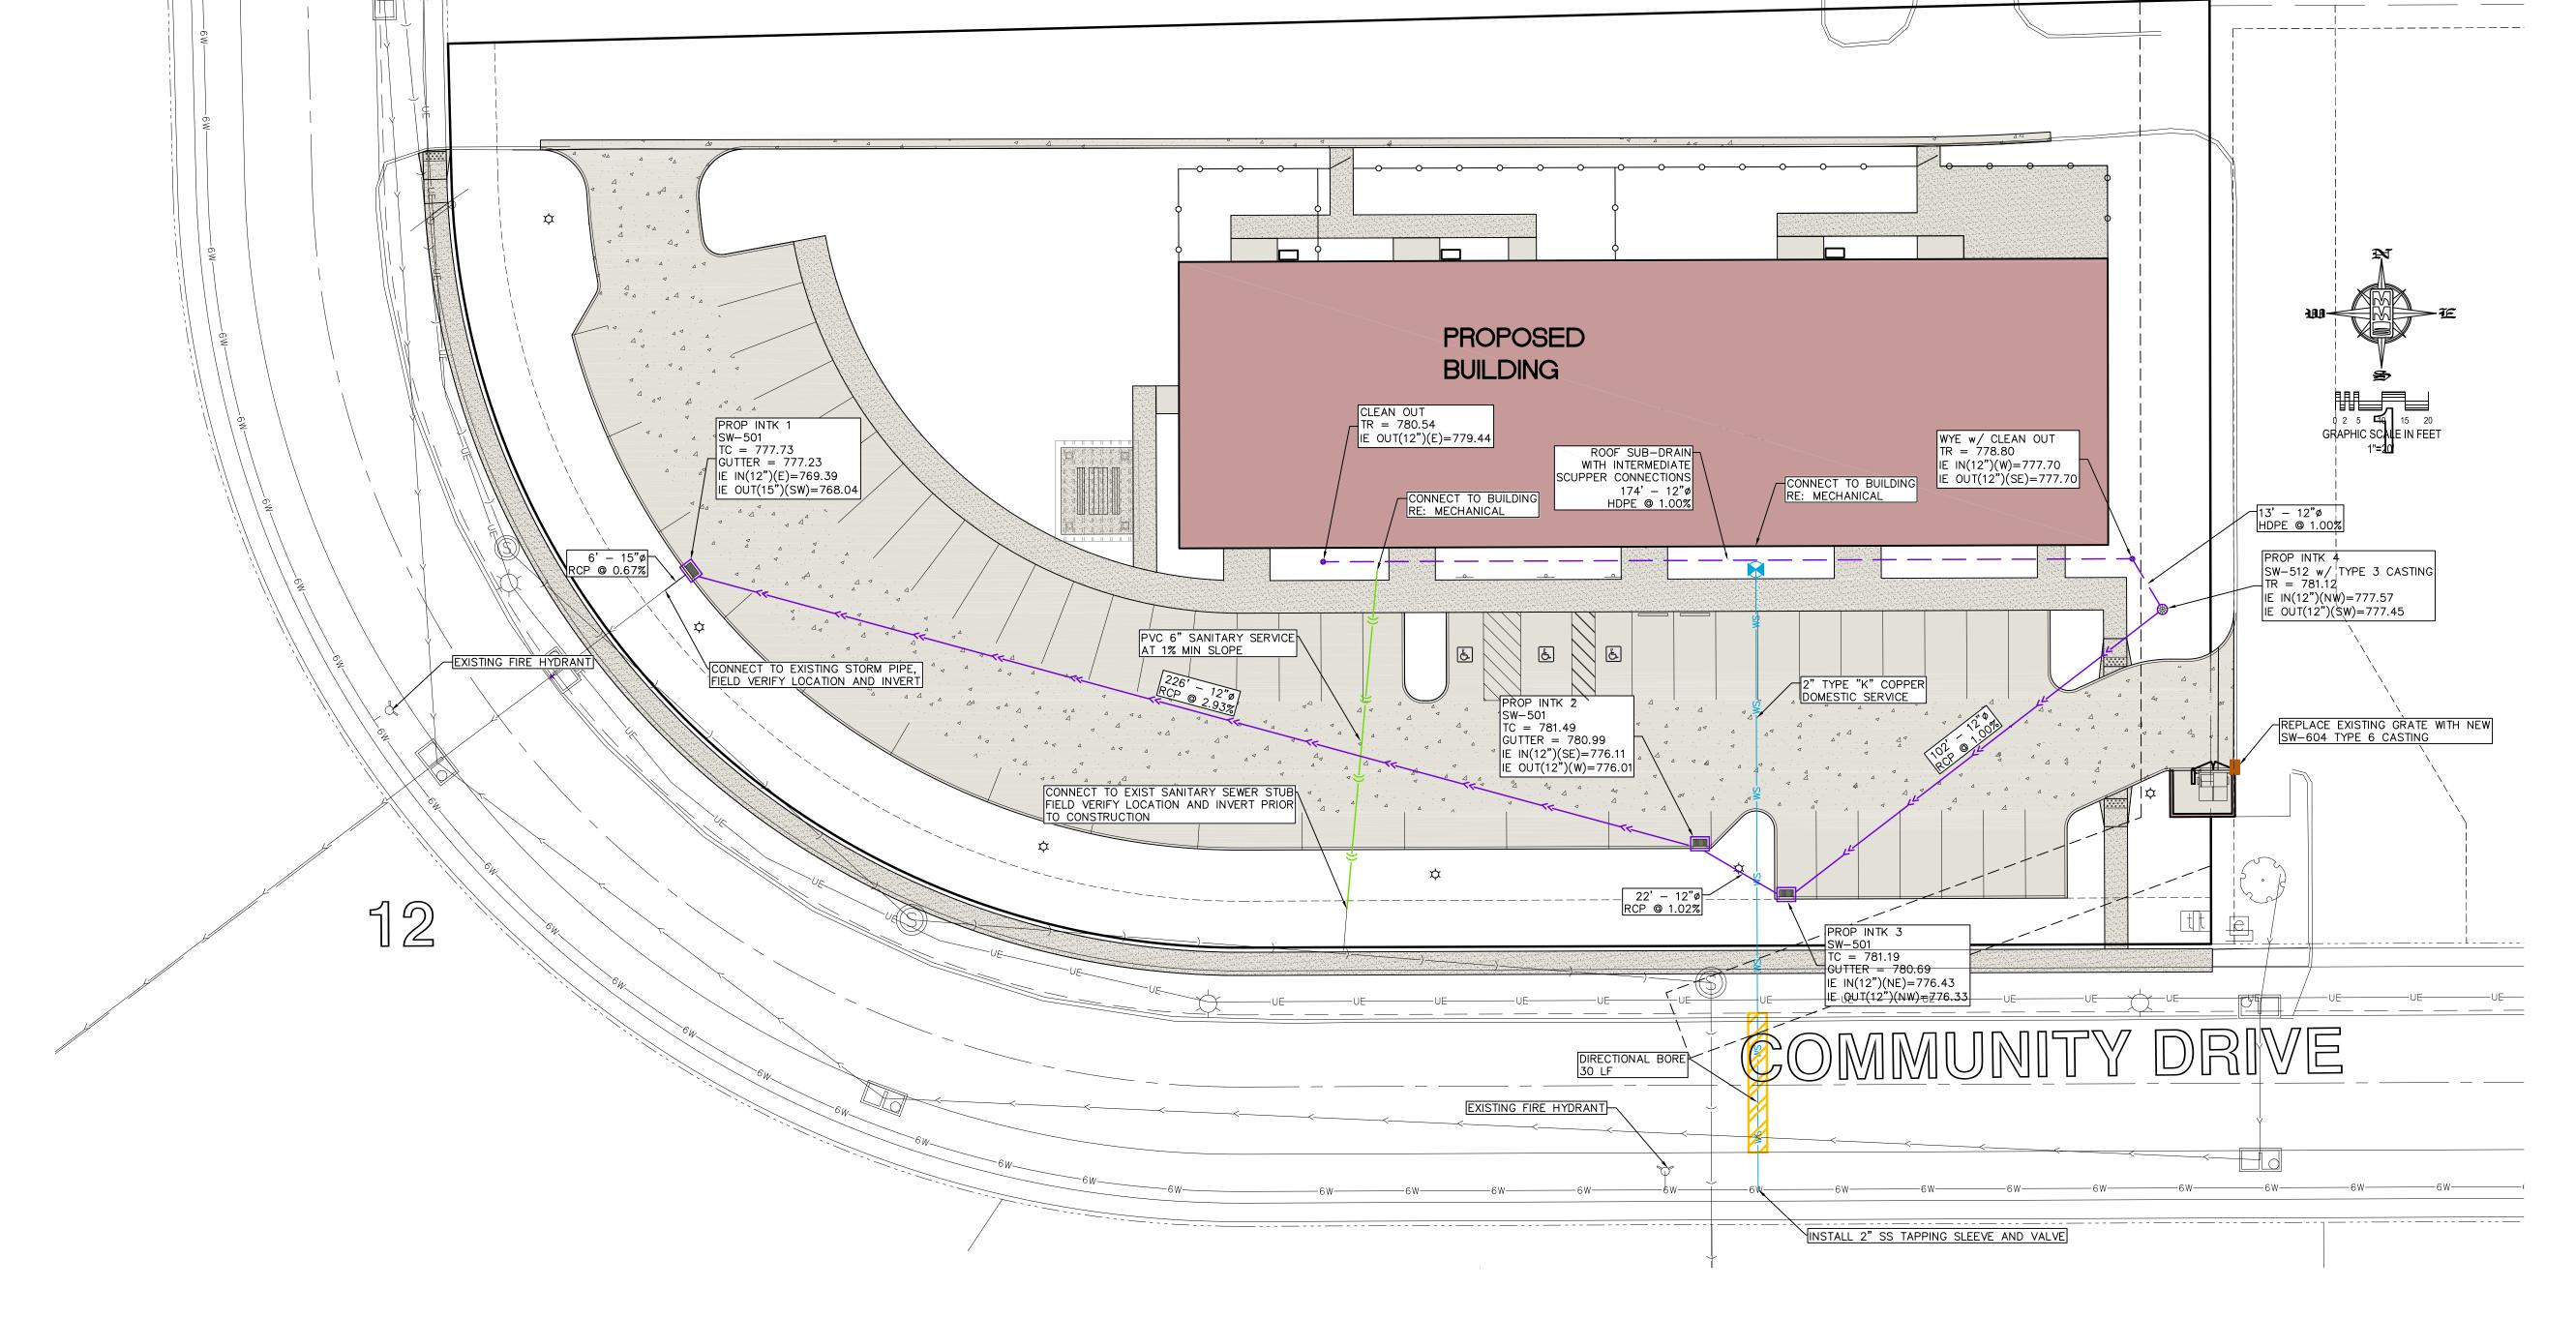

THE CONTRACTOR SHALL NOTIFY IOWA
ONE CALL NO LESS THAN 48 HRS. IN
ADVANCE OF ANY DIGGING OR EXCAVATION.

WHERE PUBLIC UTILITY FIXTURES ARE SHOWN AS EXISTING ON THE PLANS OR ENCOUNTERED WITHIN

THE CONSTRUCTION AREA, IT SHALL BE THE RESPONSIBILITY OF THE CONTRACTOR TO NOTIFY THE

SHALL AFFORD ACCESS TO THESE FACILITIES FOR NECESSARY MODIFICATION OF SERVICES.

UNDERGROUND FACILITIES, STRUCTURES AND UTILITIES HAVE BEEN PLOTTED FROM AVAILABLE SURVEYS AND RECORDS, AND THEREFORE THEIR LOCATIONS MUST BE CONSIDERED APPROXIMATE

ONLY. IT IS POSSIBLE THERE MAY BE OTHERS, THE EXISTENCE OF WHICH IS PRESENTLY NOT KNOWN

OR SHOWN. IT IS THE CONTRACTOR'S RESPONSIBILITY TO DETERMINE THEIR EXISTENCE AND EXACT

LOCATION AND TO AVOID DAMAGE THERETO. NO CLAIMS FOR ADDITIONAL COMPENSATION WILL BE

ALLOWED TO THE CONTRACTOR FOR ANY INTERFERENCE OR DELAY CAUSED BY SUCH WORK.

OWNERS OF THOSE UTILITIES PRIOR TO THE BEGINNING OF ANY CONSTRUCTION. THE CONTRACTOR

CIVIL ENGINEERS

LAND PLANNERS

LAND SURVEYORS

1917 S. GILBERT ST.

(319) 351-8282

IOWA CITY, IOWA 52240

www.mmsconsultants.net

LANDSCAPE ARCHITECTS

ENVIRONMENTAL SPECIALISTS

Date Revision

0 2 5 10 15 20

GRAPHIC SCALE IN FEET

1"=20'

SHEET INDEX

3 SITE UTILITY PLAN

4 SITE LANDSCAPE PLAN

2 SITE GRADING PLAN AND SWPPP

5 GENERAL NOTES AND DETAILS

LANDSCAPE REQUIREMENT				
•				

INSTALL SIZE

2" CAL.

INSTALL SIZE

| 12" HT. | CONT.

12" HT. CONT.

24" HT. CONT.

24" HT. CONT.

COMMON NAME

COMMON NAME

MATURE SIZE

60' X 40'

MATURE SIZE

2' X 2'

4' X 2'

5' X 5'

6' X 4'

COMMENT

2" CAL. B&B 60' X 30'

B & B

2" CAL. B&B 60' X 40'

COMMENT

PLANT LIST - TREES

3 QP QUERCUS PALUSTRIS

2 | UN | ULMUS 'NEW HORIZON'

36 BT BERBERIS THUNBERGII 'CRIRUZAM'

) | EA | EUØNYMUS ALATUS 'RUDY HAAG'

MS MISCANTHUS SINENSIS 'GRACILLIMUS'

BOTANICAL NAME

BOTANICAL NAME

3 | 65 | GLEDISTA TRIACANTHOS INTERMIS 'SKYLINE' | SKYLINE THORNLESS HONEYLOCUST

50 CA CALAMAGROSTIG X ACUTIFLORA 'KARL FOERSTER' KARL FOERSTER FEATHER REED GRASS

PIN OAK

NEW HORIZON ELM

CRIMSON RUBY BARBERRY

RUDY HAAG BURNING BUSH

GRACILLIMUS MAIDEN GRASS

PLANT LIST - SHRUBS, PERENNIALS, ORNAMENTAL GRASSES & GROUNDCOVER

RTY KEY

QTY KEY

1 TREE WITHIN 40' OF EVERY PARKING SPACE PROVIDED

- 12,000 / 2,000 = 6 TREES REQUIRED

1 TREE FOR EVERY 2,000 SF OF COMMERCIAL BUILDING FOOTPRINT.

8 TREES PROVIDED

PARKING AREAS TO BE SCREENED FROM PUBLIC VIEW. PROVIDED

- SOD

LANDSCAPE LEGEND:

- SEED WITH MULCHING + + + + +

WOOD MULCH

STANDARD LEGEND AND NOTES - PROPERTY &/or BOUNDARY LINES — — — — — CONGRESSIONAL SECTION LINES - EXISTING RIGHT-OF-WAY LINES —— — CENTER LINES - EXISTING CENTER LINES - LOT LINES, INTERNAL - LOT LINES, PLATTED OR BY DEED — — — — — — — PROPOSED EASEMENT LINES ---- EXISTING EASEMENT LINES BENCHMARK - RECORDED DIMENSIONS -EXIST-- POWER POLE W/DROP POWER POLE W/TRANS POWER POLE W/LIGHT GUY POLE - LIGHT POLE - SANITARY MANHOLE 1 SITE LAYOUT AND DIMENSION PLAN FIRE HYDRANT WATER VALVE - DRAINAGE MANHOLE - CURB INLET

> THE CONTRACTOR SHALL PROVIDE TRAFFIC CONTROL PER IDOT STANDARD ROAD PLANS AND CITY OF NORTH LIBERTY REQUIREMENTS AT ALL TIMES DURING WORK WITHIN PUBLIC R.O.W.

FOR ANY REQUIRED RELOCATION OF EXISTING UTILITIES.


THE CONTRACTOR SHALL NOTIFY IOWA ONE CALL NO LESS THAN 48 HRS. IN ADVANCE OF ANY DIGGING OR EXCAVATION.


WHERE PUBLIC UTILITY FIXTURES ARE SHOWN AS EXISTING ON THE PLANS OR ENCOUNTERED WITHIN WHERE PUBLIC UTILITY FIXTURES ARE SHOWN AS EXISTING ON THE PLANS OR ENCOUNTERED WITHIN THE CONSTRUCTION AREA, IT SHALL BE THE RESPONSIBILITY OF THE CONTRACTOR TO NOTIFY THE OWNERS OF THOSE UTILITIES PRIOR TO THE BEGINNING OF ANY CONSTRUCTION. THE CONTRACTOR SHALL AFFORD ACCESS TO THESE FACILITIES FOR NECESSARY MODIFICATION OF SERVICES. UNDERGROUND FACILITIES, STRUCTURES AND UTILITIES HAVE BEEN PLOTTED FROM AVAILABLE SURVEYS AND RECORDS, AND THEREFORE THEIR LOCATIONS MUST BE CONSIDERED APPROXIMATE ONLY. IT IS POSSIBLE THERE MAY BE OTHERS, THE EXISTENCE OF WHICH IS PRESENTLY NOT KNOWN OR SHOWN. IT IS THE CONTRACTOR'S RESPONSIBILITY TO DETERMINE THEIR EXISTENCE AND EXACT LOCATION AND TO AVOID DAMAGE THERETO. NO CLAIMS FOR ADDITIONAL COMPENSATION WILL BE ALLOWED TO THE CONTRACTOR FOR ANY INTERFERENCE OR DELAY CAUSED BY SUCH WORK.

> LIBERTY CENTRE PART ONE, LOT 10 NORTH LIBERTY JOHNSON COUNTY IOWA

MMS CONSULTANTS, INC. 05-02-19

IOWA CITY 10355-003

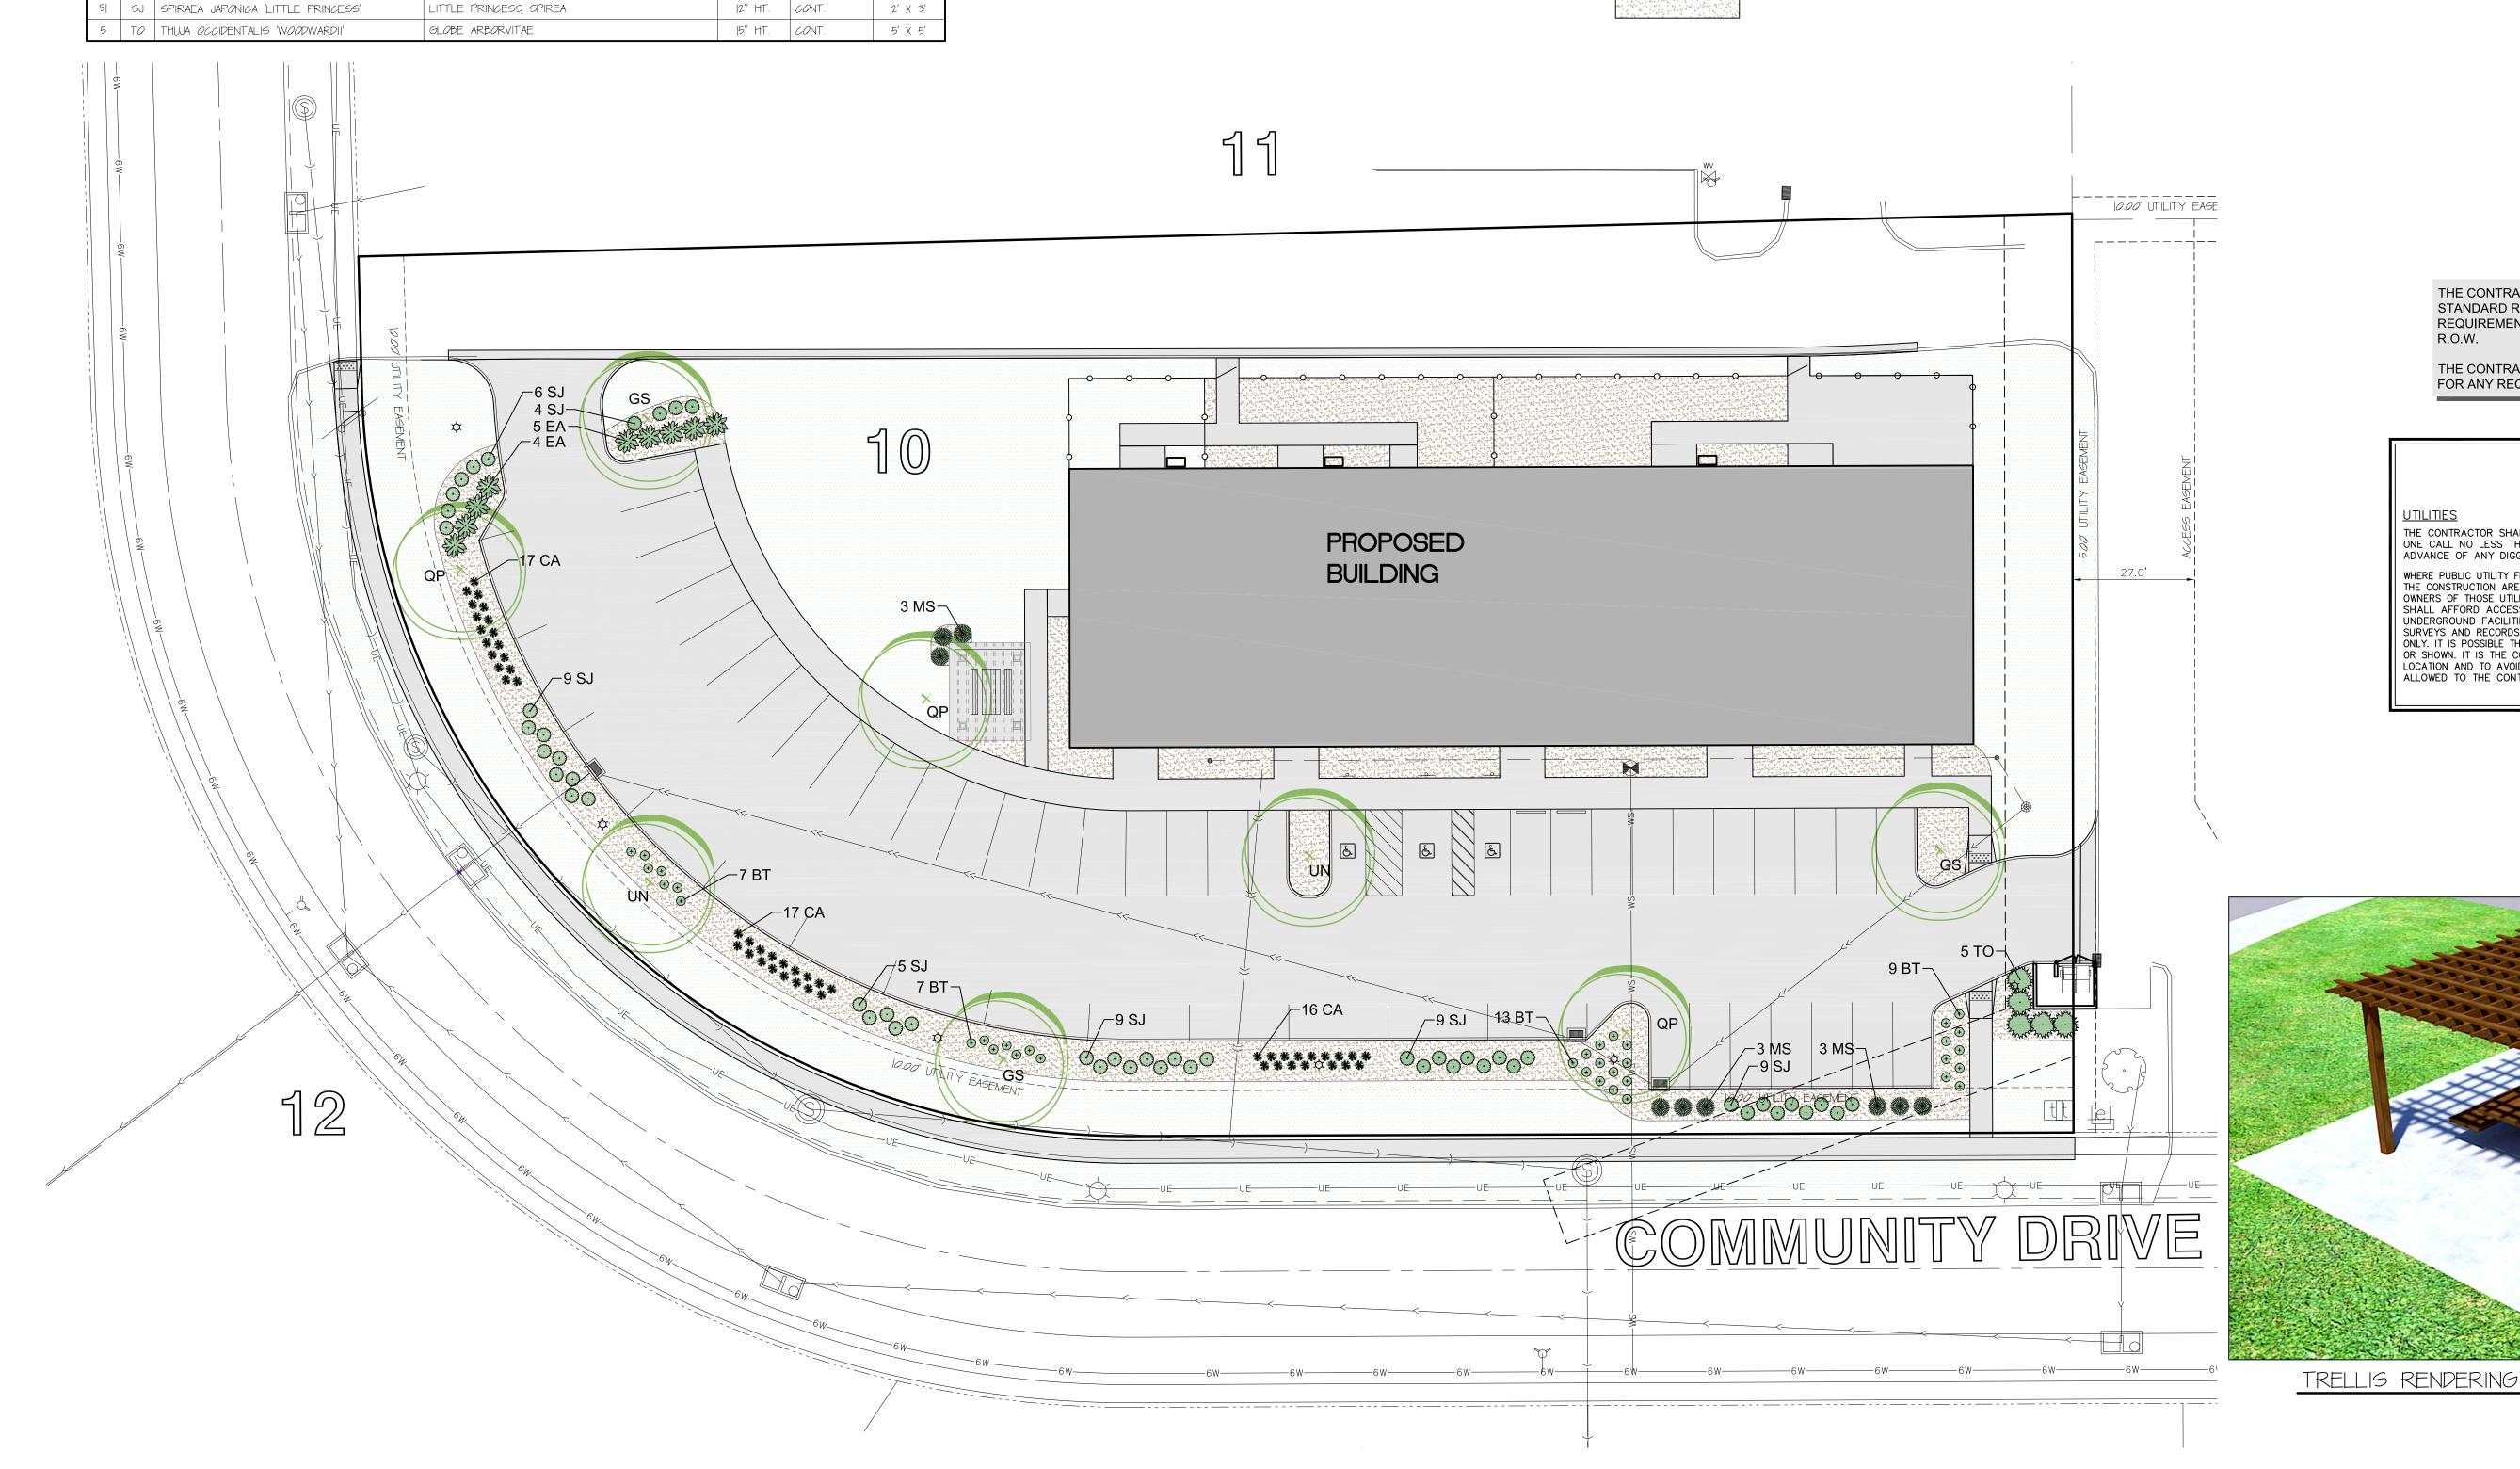

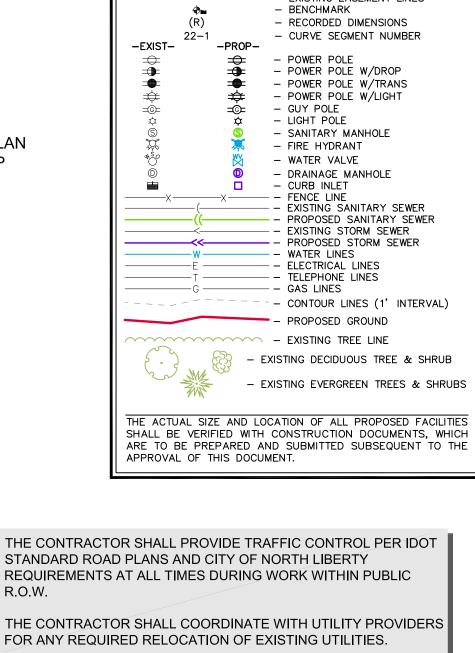

LANDSCAPE PLAN

SHEET INDEX

1 SITE LAYOUT AND DIMENSION PLAN

6" STANDARD CURB DETAIL

NOTE: SAWCUT CONTROL

JOINT 10' O.C.

PREPARED SUB GRADE

- 2 SITE GRADING PLAN AND SWPPP



CIVIL ENGINEERS ENVIRONMENTAL SPECIALISTS 1917 S. GILBERT ST. IOWA CITY, IOWA 52240 (319) 351-8282

www.mmsconsultants.net

Date Revision

LAND PLANNERS LAND SURVEYORS LANDSCAPE ARCHITECTS

GENERAL NOTES AND DETAILS

LIBERTY CENTRE PART ONE, LOT 10 NORTH LIBERTY JOHNSON COUNTY IOWA

MMS CONSULTANTS, INC.

05-02-19 Designed by: Field Book No: Drawn by: Checked by: Project No:

IOWA CITY

10355-003

3 SITE UTILITY PLAN 4 SITE LANDSCAPE PLAN 5 GENERAL NOTES AND DETAILS

PAVING CONSTRUCTION NOTES

I. PAVEMENT CONSTRUCTION SHALL BE IN ACCORDANCE WITH I.D.O.T. SPECIFICATION SECTION 2301.

PLAN PV-101.

INCHES. UNLESS NOTED OTHERWISE.

5. ALL SAWED PAVEMENT JOINTS SHALL BE SEALED.

2. I.D.O.T. CLASS C-3 CONCRETE SHALL BE USED, UNLESS NOTED

PAVEMENT JOINTS SHALL CONFORM TO I.D.O.T. STANDARD ROAD

SUBGRADE UNDER PROPOSED PAVEMENT SHALL BE COMPACTED


TO 95% STANDARD PROCTOR DENSITY, TO A DEPTH OF SIX (6)

1) ALL STORM SEWER AND SUB-SURFACE CONSTRUCTION SHALL CONFORM TO PLANS AND DETAILS PREPARED FOR THIS PROJECT BY MMS CONSULTANTS, INC., AS WELL AS CONFORM TO THE IOWA STATEWIDE URBAN DESIGN AND SPECIFICATIONS (SUDAS) MANUAL. CONSTRUCTION SHALL ALSO CONFORM TO THE CURRENT CITY OF NORTH LIBERTY DESIGN STANDARDS, WHICH SHALL SUPERSEDE PLANS AND DETAILS PROVIDED BY MMS CONSULTANTS. ACCESSIBLE SIGN DETAIL 2) ALL STORM SEWER INTAKE AND MANHOLE LIDS SHALL HAVE THE WORDS "STORM SEWER" CAST INTO THE LID.

3) ALL REINFORCED CONCRETE PIPE STORM SEWER SHALL BE CLASS III UNLESS NOTED OTHERWISE IN THE PLANS. 4) ALL REINFORCED CONCRETE PIPE (RCP) SHALL CONFORM TO SUDAS SPECIFICATION 4020,2.01,A WITH THE FOLLOWING ADDITIONAL

STORM SEWER AND SUB-SURFACE CONSTRUCTION NOTES

- RESTRICTIONS: ALL RCP JOINTS FOR 36" AND SMALLER PIPE SHALL HAVE TONGUE AND GROOVE JOINTS INCORPORATING RUBBER "O"-RING OR PROFILE GASKETS COMPLYING WITH ASTM C443 OR SHALL BE TONGUE AND GROOVE WITH ALL JOINTS WRAPPED WITH FILTER FABRIC A MINIMUM OF 24" WIDE.
- 5) RCP PIPE BEDDING SHALL CONFORM TO SUDAS FIGURE 3010.102 CLASS R-1. CLASS 1 BEDDING MATERIAL SHALL BE AS SPECIFIED IN SUDAS SPECIFICATION 3010,2.02,A. TRENCH BACKFILL SHALL BE SUITABLE EXCAVATED MATERIAL AS IDENTIFIED IN SUDAS SPECIFICATION 3010,2.01,A PLACED AND COMPACTED IN ACCORDANCE WITH SECTIONS 3.05, D AND E. THE OWNER MAY ELECT TO TEST TRENCH COMPACTION AT THEIR OWN EXPENSE.
- 6) SUB-SURFACE DRAINAGE PIPE SHALL BE HIGH DENSITY POLYETHYLENE PIPE (HDPE) CONFORMING TO SUDAS SPECIFICATION 4040,2.02,C FOR BOTH PERFORATED TILE AND SOLID WALL PIPE.
- 7) FOR SUB-SURFACE DRAINAGE IN TURF AREAS HDPE PIPE BEDDING SHALL CONFORM TO SUDAS FIGURE 3010.103 CLASS F-3.
 BEDDING MATERIAL SHALL BE POROUS BACKFILL MATERIAL AS SPECIFIED IN SUDAS SPECIFICATION 4040,2.04. TRENCH BACKFILL SHALL BE SUITABLE EXCAVATED MATERIAL AS IDENTIFIED IN SUDAS SPECIFICATION 3010,2.01,A PLACED AND COMPACTED IN ACCORDANCE WITH SECTIONS 3.05 D AND E.
- 8) FOR SUB-SURFACE DRAINAGE UNDER PAVEMENT HDPE PIPE INSTALLATION SHALL CONFORM TO SUDAS FIGURE 4040,2.01, CASE C TYPE 1. BEDDING AND BACKFILL MATERIAL SHALL BE AS SPECIFIED IN SUDAS SPECIFICATION 4040,2.04.
- 9) AT LOCATIONS WHERE A FLARED END SECTION IS REQUIRED, THE PIPE LENGTHS SHALL BE MEASURED TO THE END OF THE FLARED END. THE FLARED END SECTION AND THE TWO UPSTREAM JOINTS ARE TO INCORPORATE TIED JOINTS.
- 10) ALL FIELD TILE ENCOUNTERED DURING CONSTRUCTION SHALL BE CONNECTED TO THE PROPOSED STORM SEWER. NOTIFY ENGINEER OF ALL FIELD TILES ENCOUNTERED.
- 11) CONTRACTOR SHALL PROVIDE A FIVE-YEAR MAINTENANCE BOND COVERING DEFECTIVE MATERIALS AND WORKMANSHIP FOR ALL

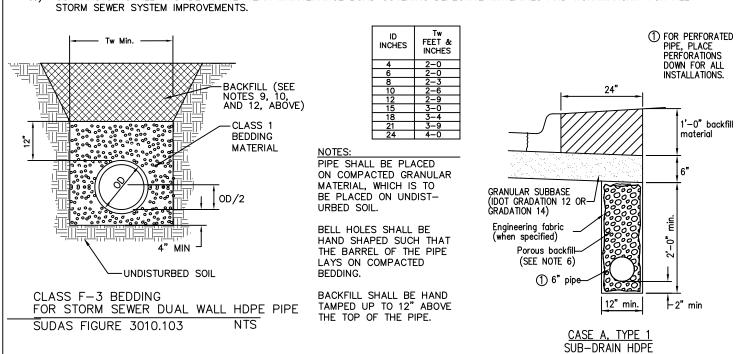



ACCESSIBLE PARKING STATE PERMIT REQUIRED 2"x2" GALVANIZED PERFORATED STEEL SIGN POST ACCESSIBLE 5"x5"x1/2" STEEL TUBING, POWDER COAT BLUE, CONCRETE FILLED; DRIVE 2"x2" SQUARE SIGN POST INTO CONCRETE CONCRETE PAVING EXPANSION JOINT


ACCESSIBLE PARKING DETAIL

NOTE: DUMPSTER ENCLOSURE SHALL BE CONSTRUCTED WITH MATERIALS

ACCESSIBLE PARKING SYMBOL

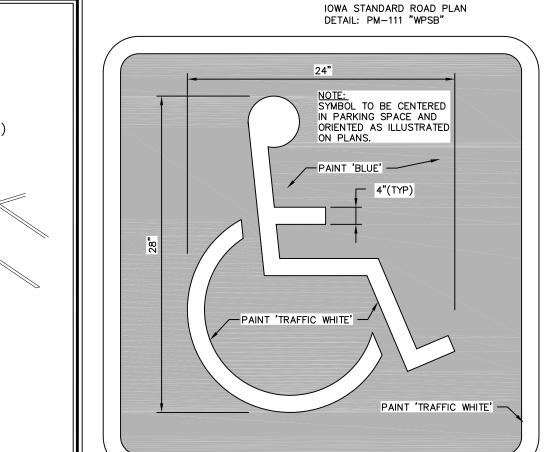

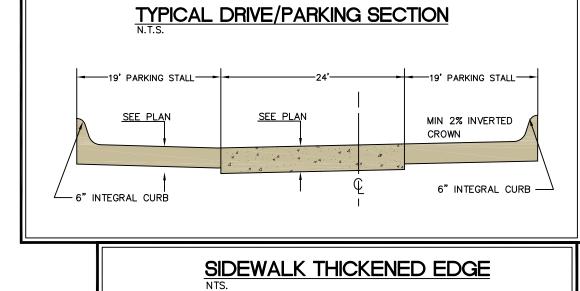

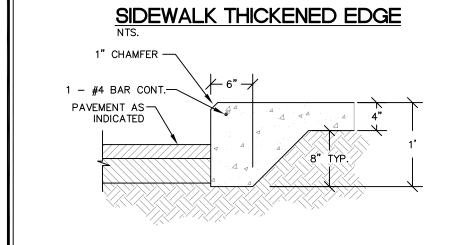

DOWNSPOUT TO ROOF

DRAIN SEWER CONNECTION DETAIL

CONNECTIONS REQUIRED

CONNECT DOWNSPOUT WITH AN EXTENSION -OF LIKE MATERIAL, SIZE AND COLOR, INSTALL ELBOWS AS NECESSARY TO CONNECT TO PVC ROOF DRAIN

CONNECT DOWNSPOUT WITH AN ADAPTER — MATCHING THE SIZE, SHAPE AND COLOR OF DOWNSPOUT, OR DEFORM END AS

NECESSARY TO INSERT DOWNSPOUT INTO PVC ROOF DRAIN

ROOF DRAIN DOWNSPOUT -

— PROPOSED GROUND ADJACENT TO BUILDING

SEE PLAN

- EXTERIOR

BUILDING FOUNDATION

PVC, SEE UTILITY


PLAN FOR SIZE


AND LOCATIONS


SLOPE VARIES

(SHAPE AND SIZE VARIES)

TYPICAL HEADLIGHT SCREENING DETAIL

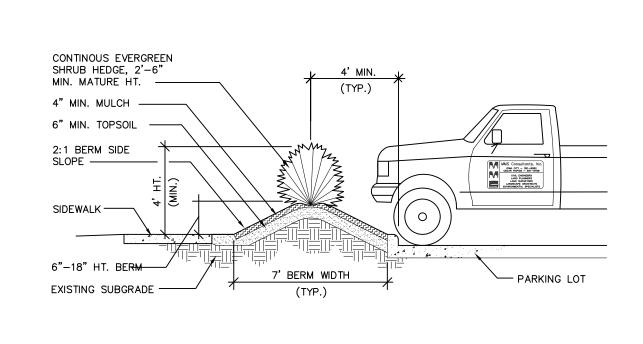


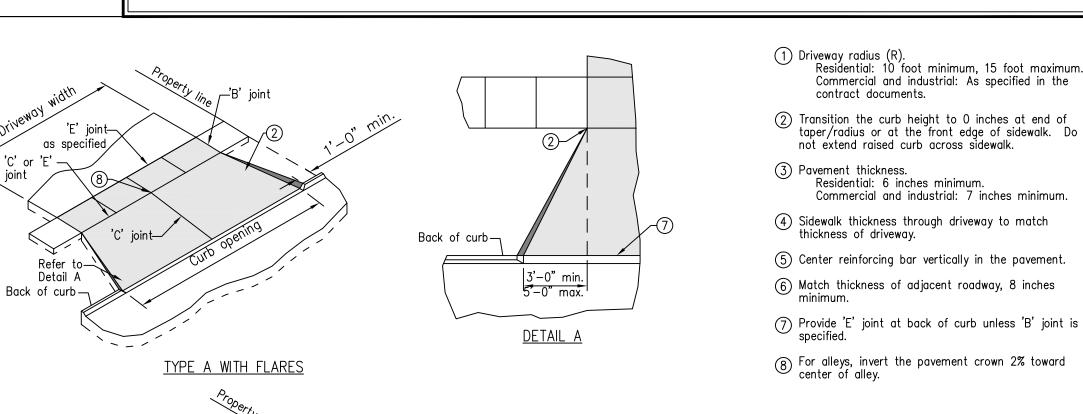

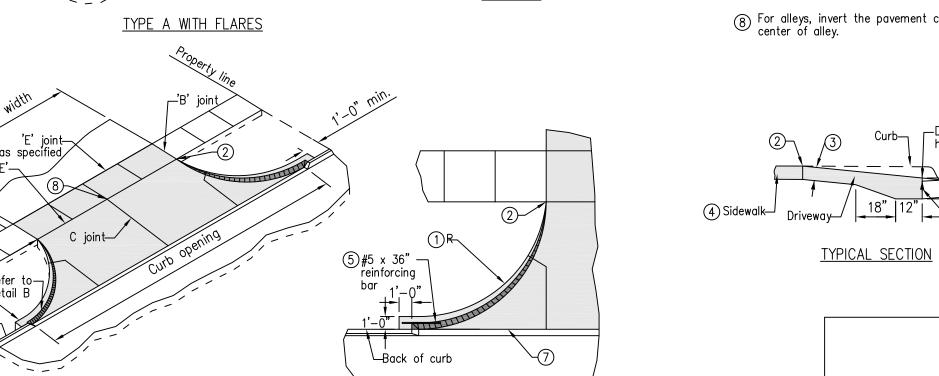


<u>DETAIL B</u>

TYPE A WITH RADII

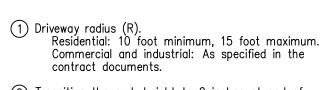

- (4) Sidewalk thickness through driveway to match
- (6) Match thickness of adjacent roadway, 8 inches

REVISION | 10/21/08 | TGURE 7030.1 SHEET 1 OF 1 CONCRETE DRIVEWAY, TYPE B

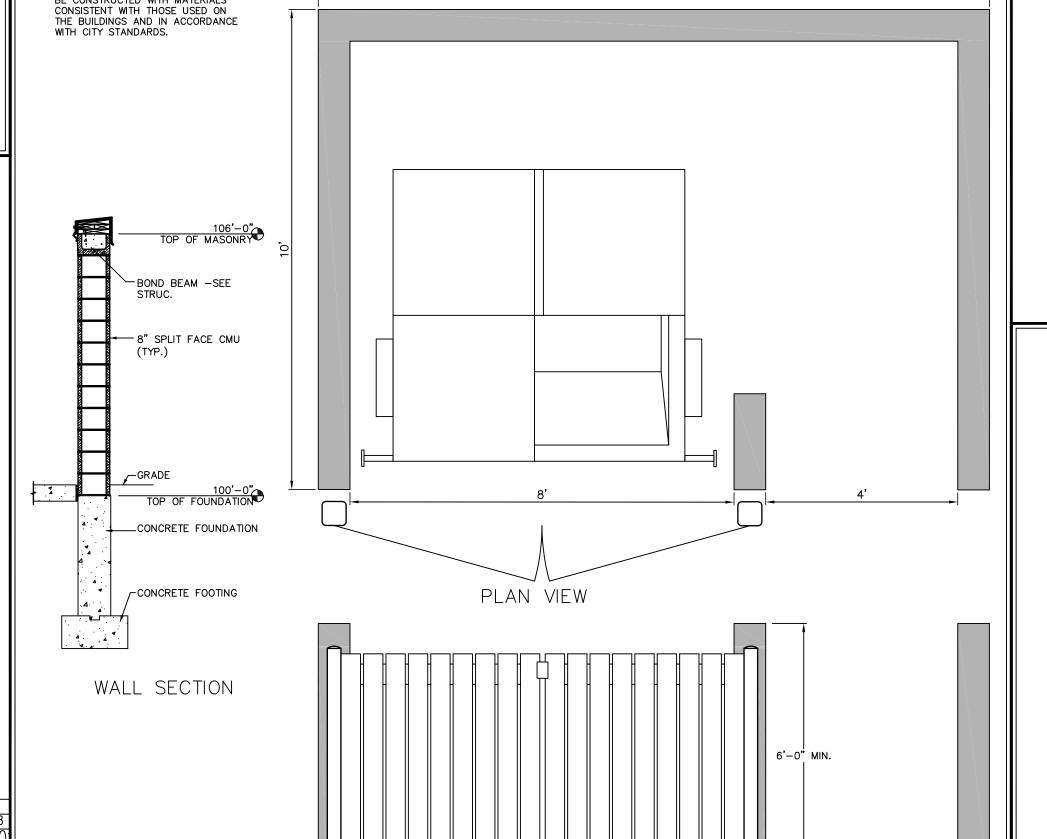

FRONT VIEW

TRASH ENCLOSURE DETAIL





Project Name:
Liberty Centre
Building #2
Day Care

Community Drive North Liberty, Iowa

Owner Project Number:

00000

CDT Project Number:

18027



1210 S. GILBERT ST SUITE 100 IOWA CITY, IA 52240 319-338-0066 PHONE 319-351-0066 FAX

Consultants:

Sheet Title:
EXTERIOR
ELEVATIONS CONDENSING
UNITS

ISSUE DATE/PROJECT STATUS 01/23/45 Status

Number Date Description

Drawn By: Checked By:

KLC BC

Sheet Number:

A-252



Liberty Centre Building #2 Day Care

Community Drive North Liberty, Iowa

Owner Project Number:

carlson design team



1210 S. GILBERT ST IOWA CITY, IA 52240 319-338-0066 PHONE 319-351-0066 FAX


Consultants:
SELECT STRUCTURAL

EXTERIOR ELEVATIONS

ISSUE DATE/PROJECT STATUS

Number	Date	Description		
1 04.01.19 V		WORKING SET		
	D	Ole a alea al Desi		
Drawn	By:	Checked By:		

Sheet Number:

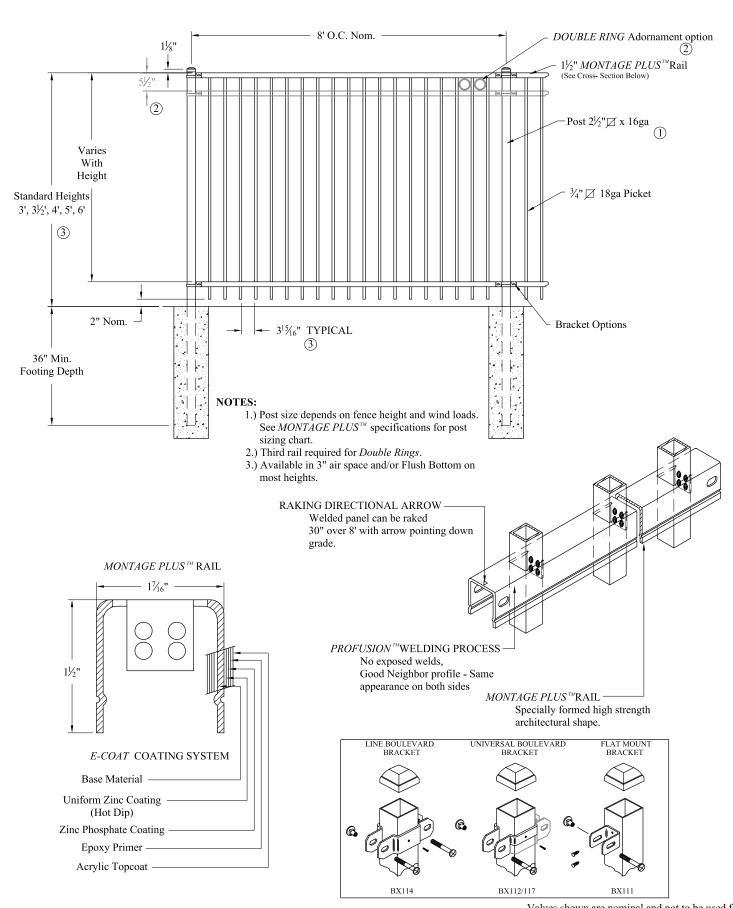

COMMERCIAL STRENGTH WELDED STEEL PANEL PRE-ASSEMBLED

Values shown are nominal and not to be used for installation purposes. See product specification for installation requirements.

MONTAGE PLUS MAJESTIC 2/3-RAIL					
DR: CI	DR: CI SH . 1 of 1 SCALE: DO NOT S				
CK: ME	Date 6/28/	10	REV: e		



1555 N. Mingo Tulsa, OK 74116 1-888-333-3422 www.ameristarfence.com

MONTAGE PLUS®



ORNAMENTAL STEEL FENCE

Montage Plus ornamental steel fence has the *versatility to fit many different project applications*. With its ability to *traverse varying grades*, variety of *distinct product styles* and unmatched coating performance, Montage Plus is the *preferred choice for ornamental fence*.





PRIMARY APPLICATIONS

- Commercial Developments
- Self Storage
- Apartments (Multi-Family)
- Parks & Recreation
- Schools & Universities






MONTAGE PLUS°

ORNAMENTAL STEEL FENCE

.75"sq x 18ga PICKETS | 1.4375" x 1.5" x 14ga RAILS | 2.5"sq x 16ga POSTS

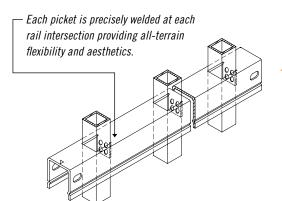

STYLE OPTIONS



Also available in Pool, Pet & Play (3" air spacing) — styles vary

PROFUSION WELDED STEEL



All Montage fence panels are fabricated using Ameristar's ProFusion welding process. This technique combines laser and fusion technology to create a virtually invisible structural connection at every picket to rail intersection. Unlike typical aluminum fence systems that are held together with unsightly screws, the ProFusion weld used with Montage promotes a "good neighbor" profile with sleek lines and no exposed picket to rail fasteners. When compared to aluminum fencing, Montage's welded steel construction is unmatched in strength and durability.



E-COAT™ PROTECTIVE FINISH

Montage galvanized steel framework is subjected to a multi-stage pre-treatment/wash (with zinc phosphate), followed by a duplex cathodic electrocoat system consisting of an epoxy primer, which significantly increases corrosion protection, and an acrylic topcoat, which provides the protection necessary to withstand adverse weathering effects. This process results in years of maintenance-free ownership.




20 YEAR LIMITED WARRANTY

The Montage families of fencing products are manufactured from superior quality materials by skilled craftsmen with the highest standards of workmanship in the industry. Ameristar is confident in offering Montage with a 20 year limited warranty.



DOMESTIC MANUFACTURING

Ameristar is committed to providing products that are manufactured in the USA. We have made significant investments in technology, process improvement, and employee training in an effort to secure American jobs and combat inferior import products.

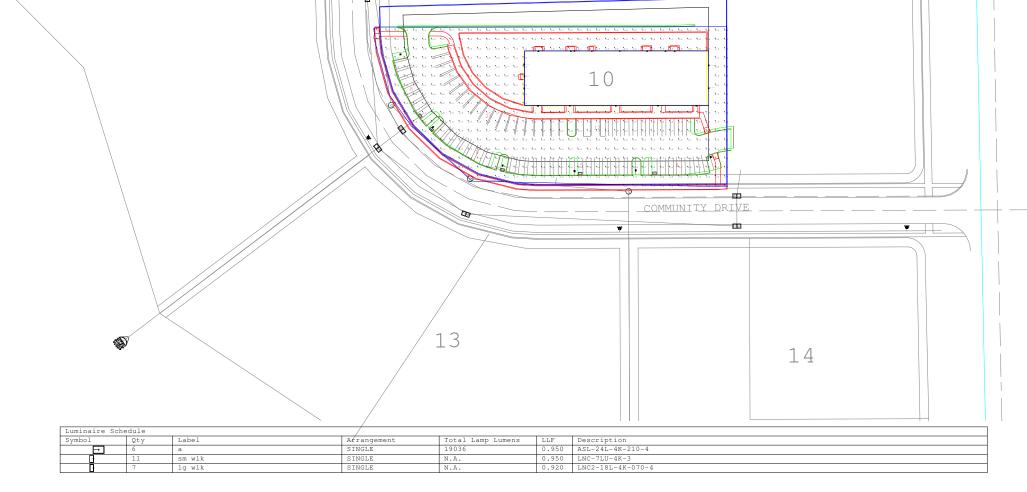

Calculation Summary							
Label	CalcType	Units	Avg	Max	Min	Avg/Min	Max/Min
parking lot_Planar	Illuminance	Fc	2.63	10.5	0.2	13.15	52.50

Home / Storage & Organization / Sheds, Garages & Outdoor Storage / Deck Boxes

Model # DB5500J Internet #203701366 Store SKU #380416



Share Save to Favorites Print

Suncast

50 Gal. Resin Deck Box


★★★★★ (1,011) Write a Review Questions & Answers (98)

- 41 in. W x 23.75 in. H x 21 in. D
- · Provides extra outdoor seating
- Easy snap together assembly


\$**59**98 \$69.98 Save \$10.00 (14%)

Quantity - 1 +

1 of 6 4/18/2019, 1:32 PM

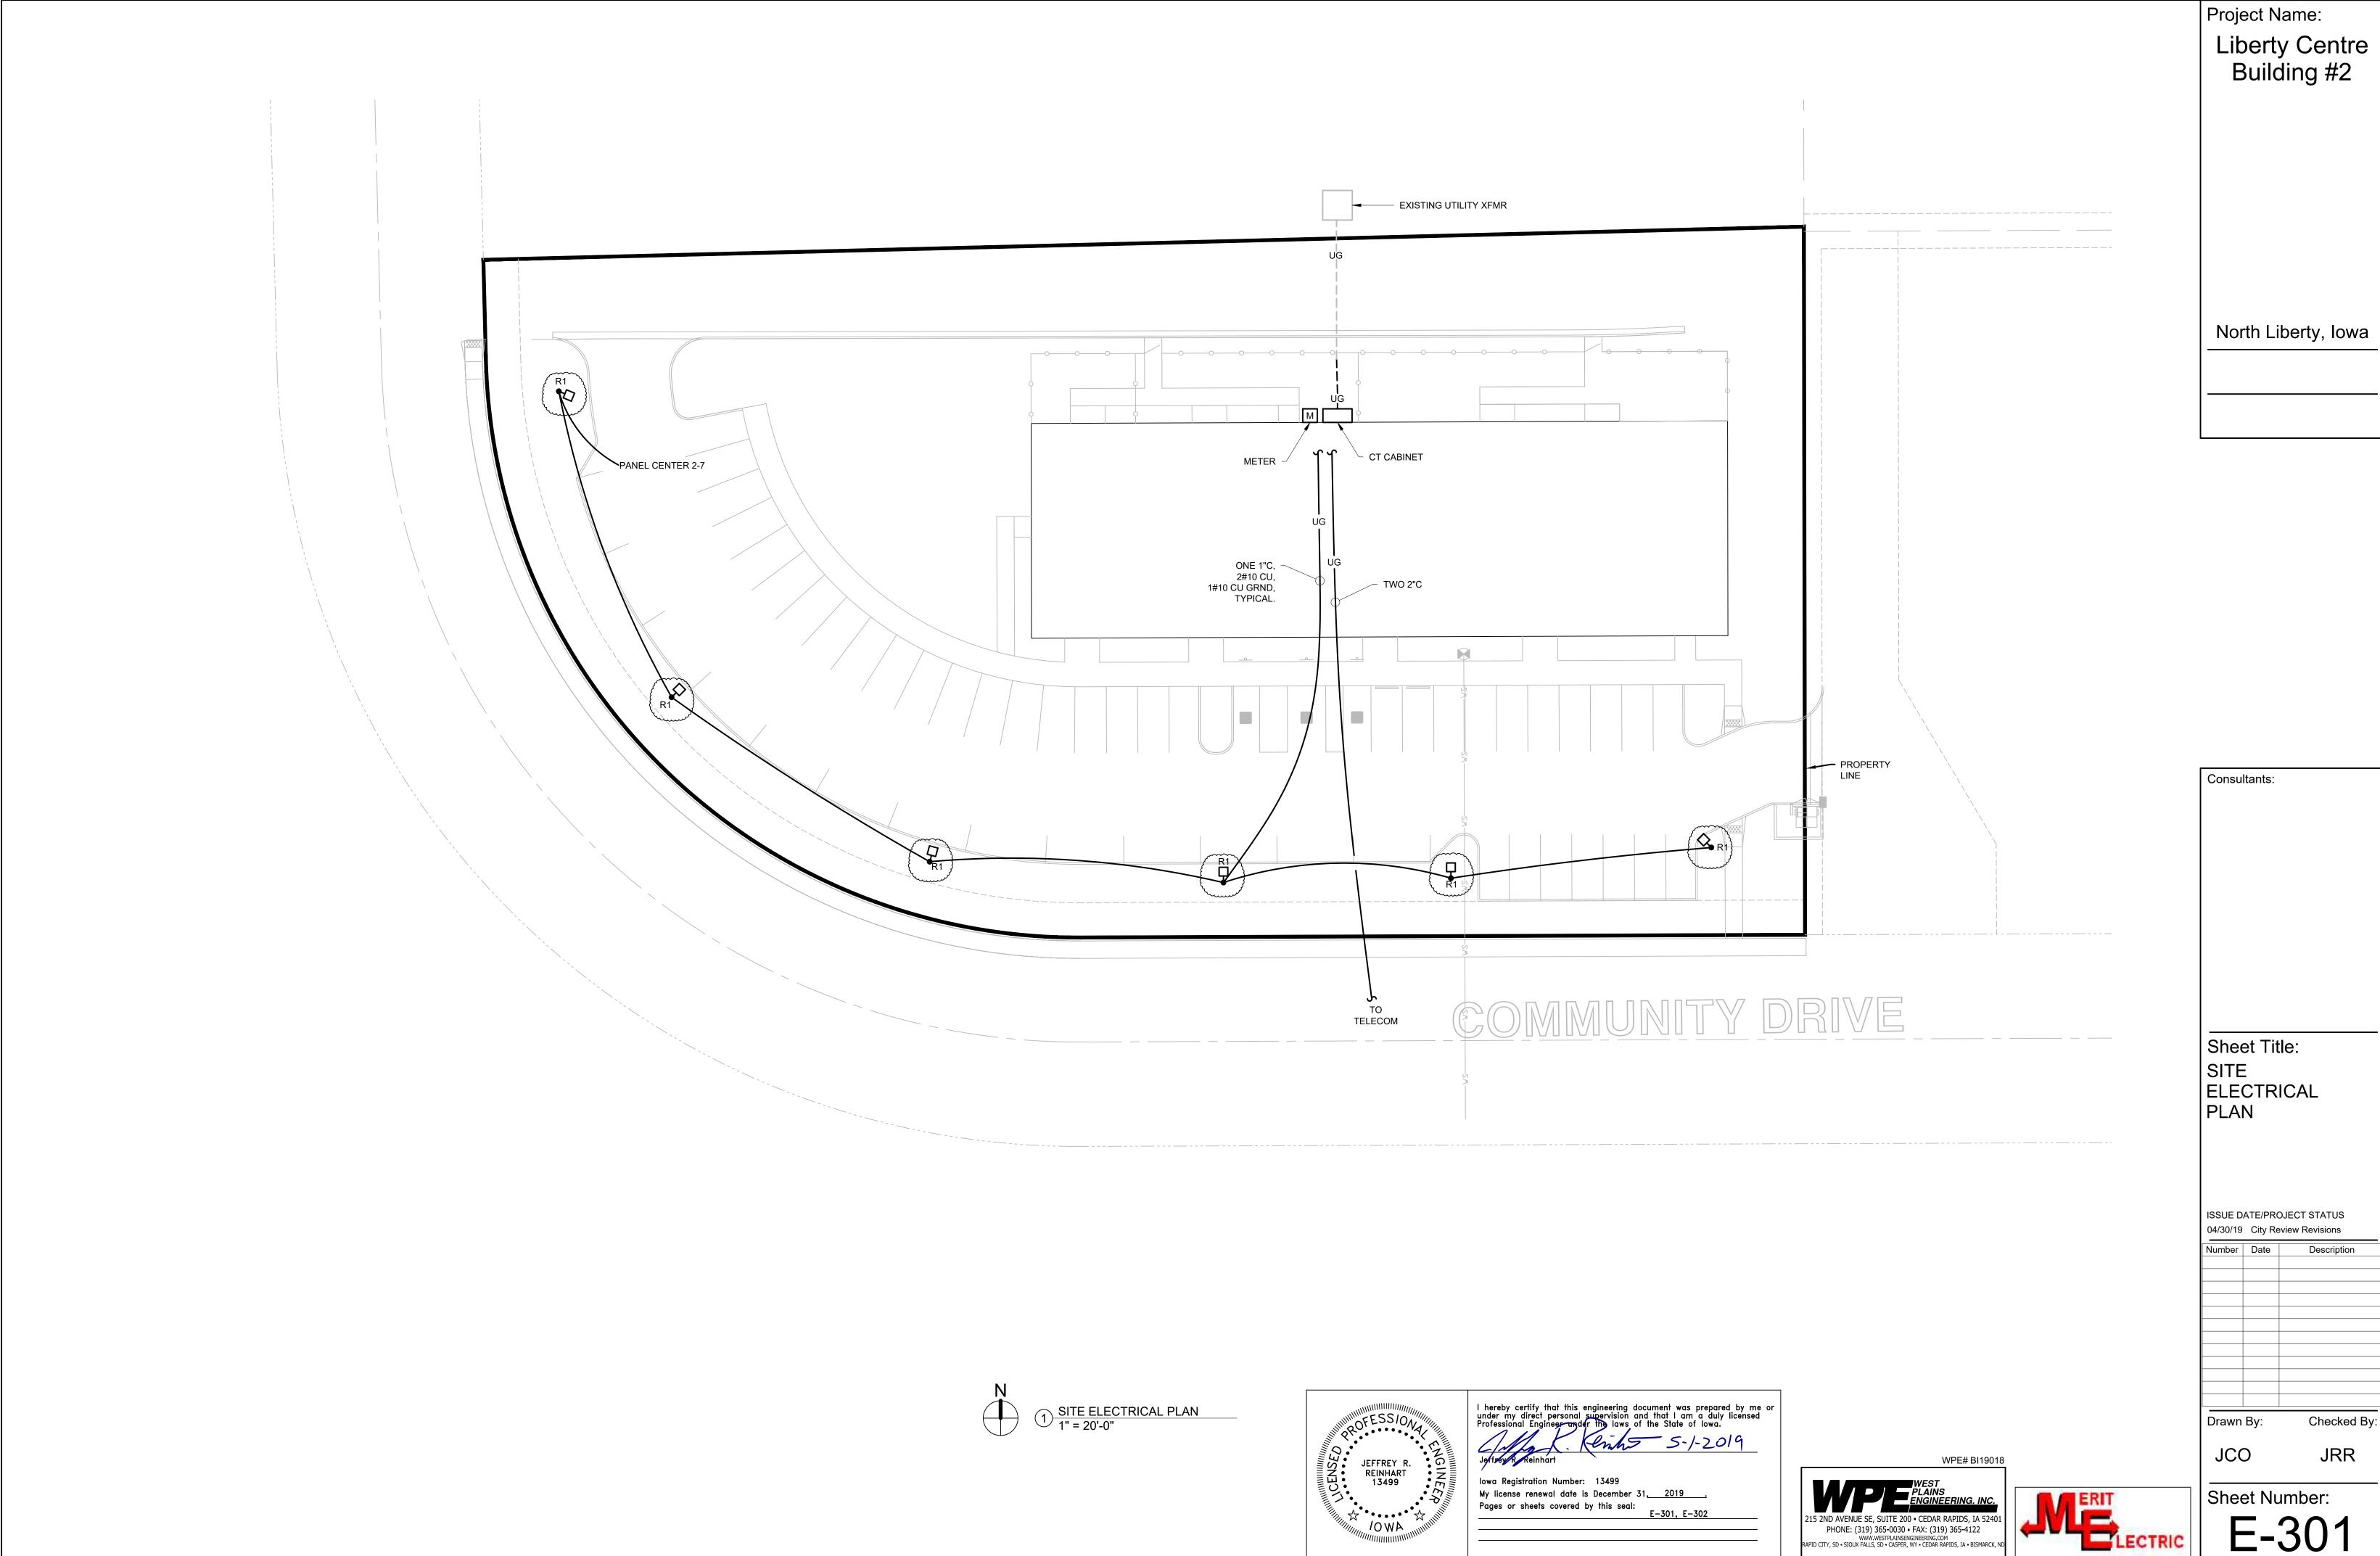

Checked By:

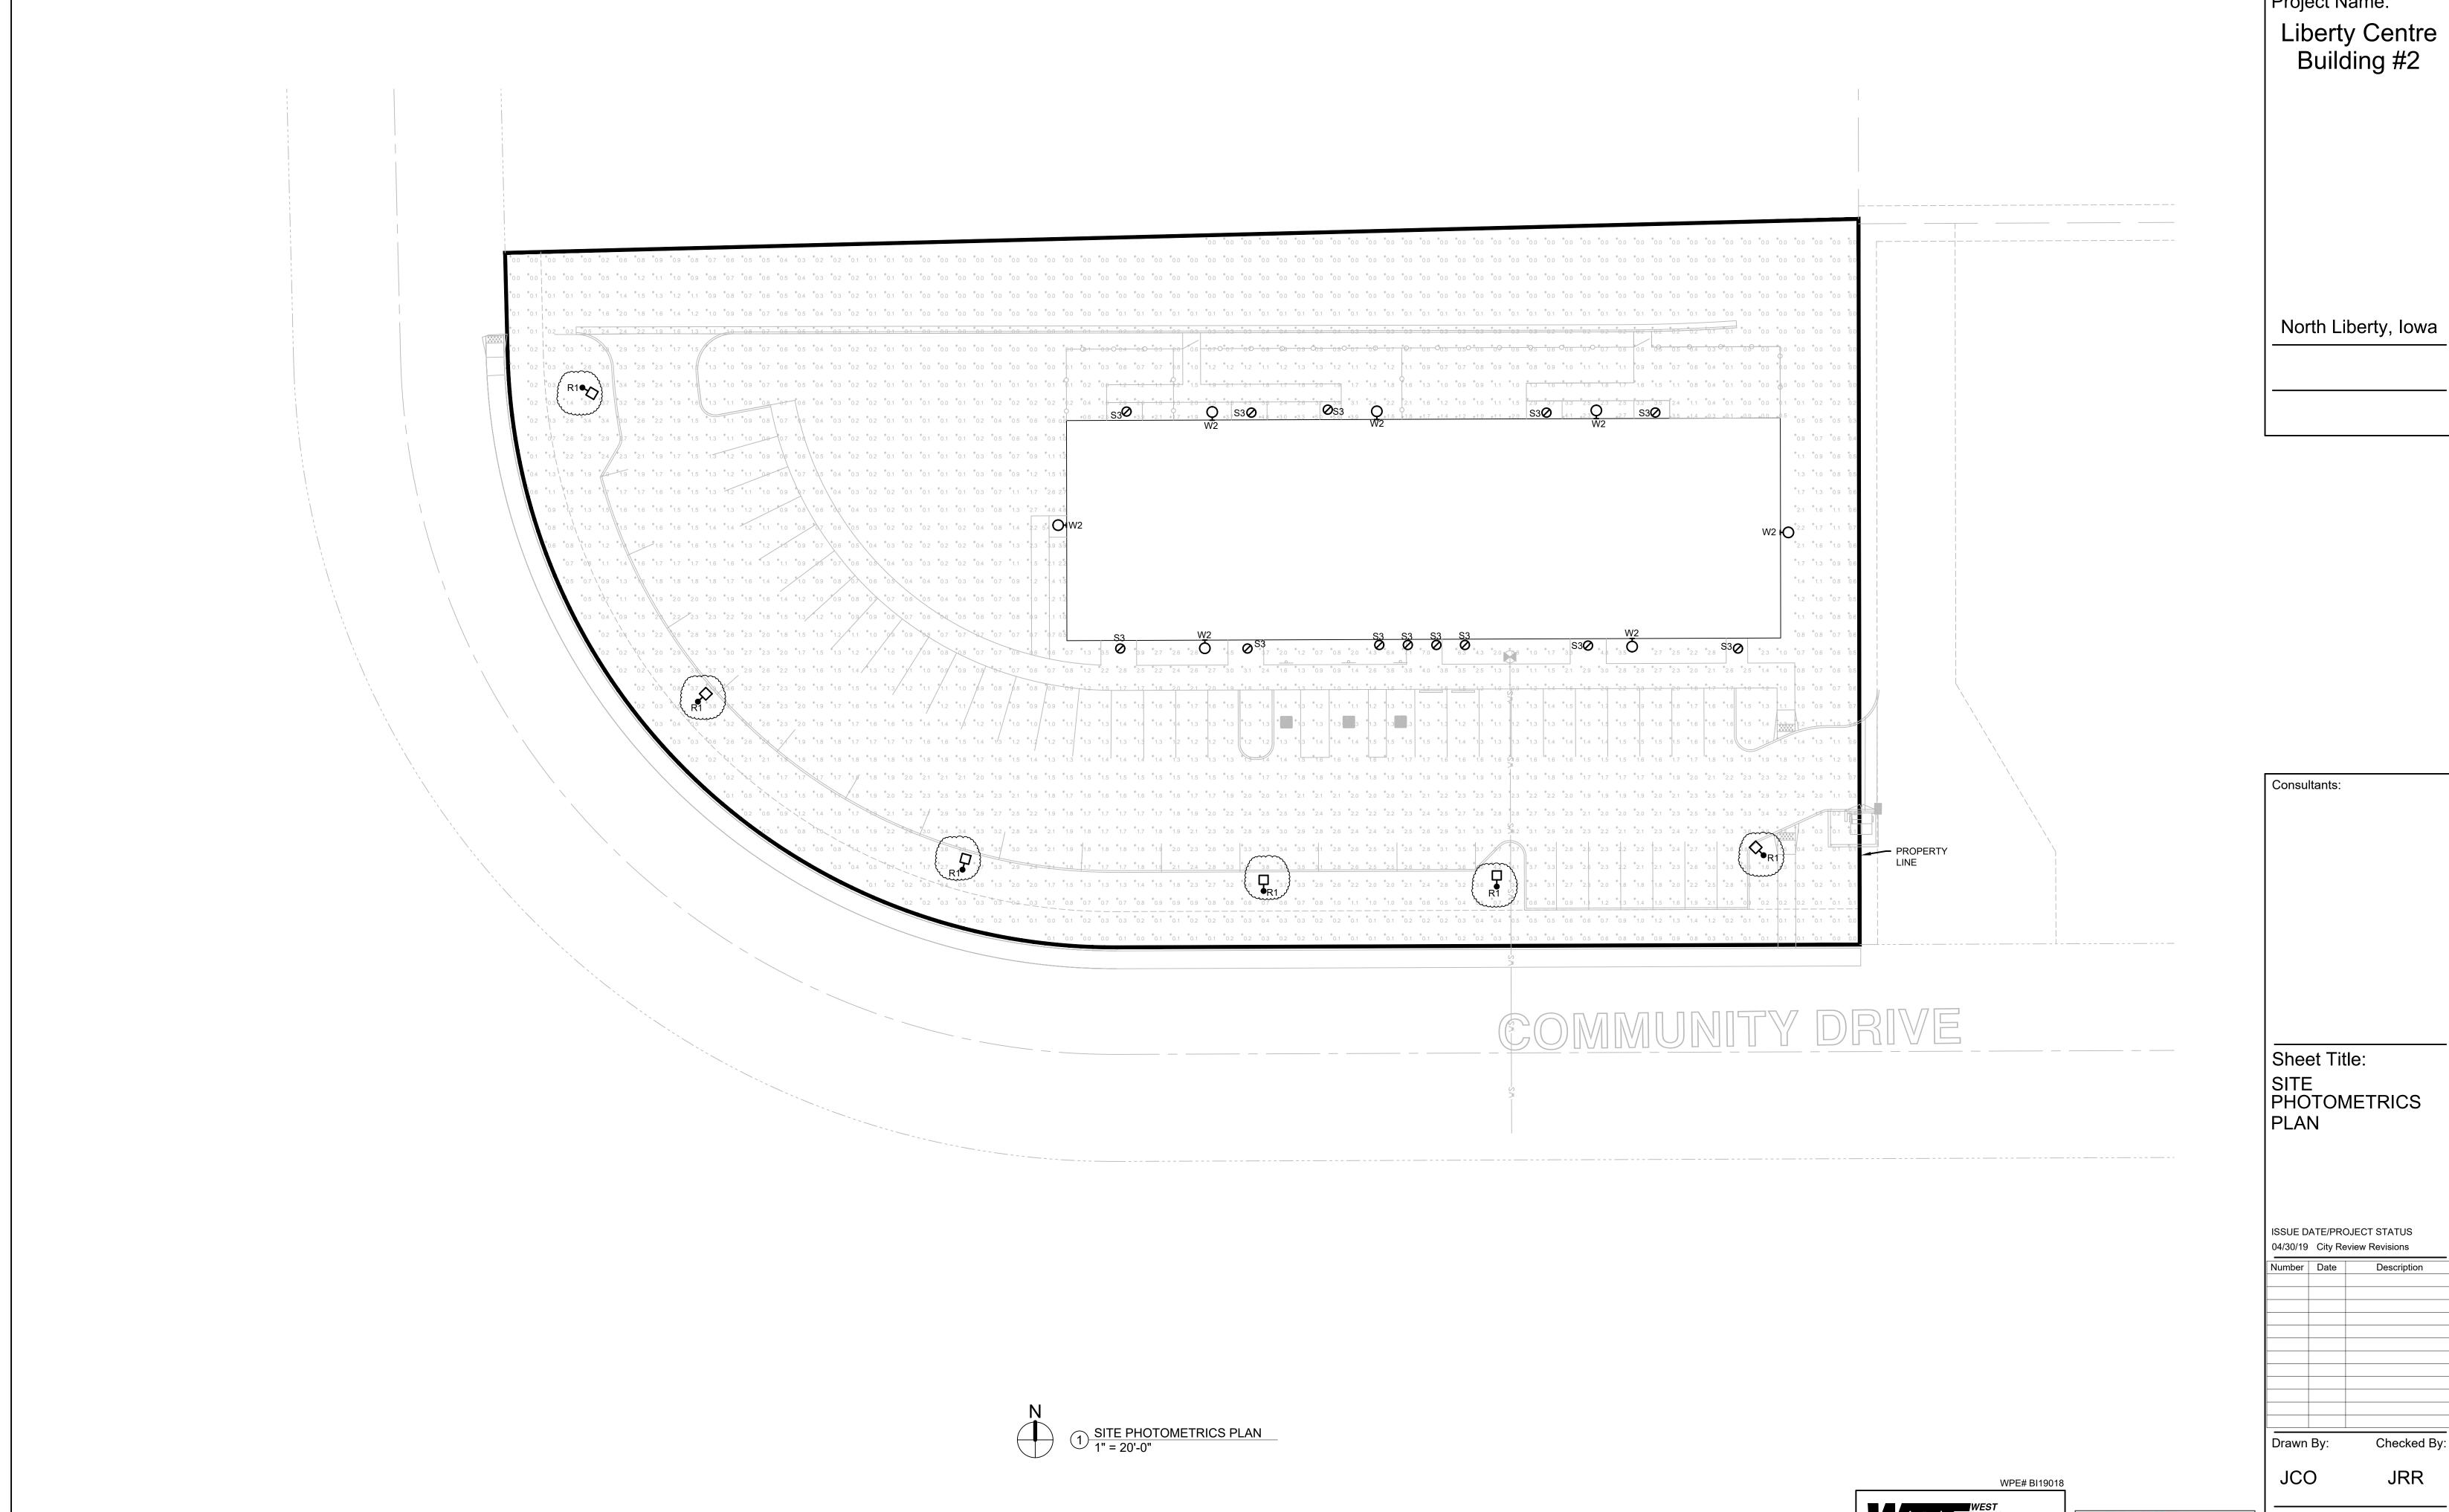

Project Name:

Sheet Number:

WWW.WESTPLAINSENGINEERING.COM RAPID CITY, SD • SIOUX FALLS, SD • CASPER, WY • CEDAR RAPIDS, IA • BISMARCK, ND



NORTH LIBERTY PLANNING COMMISSION

Minutes April 2, 2019

North Liberty City Council Chambers, 1 Quail Creek Circle

<u>Roll Call</u>

Chair Ronda Detlefsen called the April 2, 2019 Regular Session of the North Liberty Planning Commission to order. Commission members present: Jennifer Bleil, Ronda Detlefsen, Adam Gebhart, Jason Heisler, Kylie Pentecost, Patrick Staber; absent: Rebecca Keogh.

Others present: Dean Wheatley, Ryan Heiar, Tracey Mulcahey, Kevin Trom, Joel Miller, Brian Watts, Duane Musser, Carter Kurdlre and other interested parties.

Agenda Approval

Bleil moved, Staber seconded to approve the agenda. The vote was all ayes. Agenda approved.

The Preserve, Lot 1 Site Plan

Staff Presentation

Wheatley presented the request of Watts Group Development Inc to approve a multi-family site plan for Lot 1 of "The Preserve" at the southeast corner of Kansas Avenue and St. Andrews Drive. Staff recommends approval with no conditions.

Applicants Presentation

Brian Watts, The Watts Group, was present on behalf of the applicant and offered to answer questions.

Public Comments

No public comments were offered.

Questions and Comments

The Commission discussed the application including parking, the size of the shelter, open space, price point, connectivity to area open spaces, storage of trash bins in the garage, layout, and extra sidewalks.

Recommendation to the City Council

Pentecost moved, Heisler seconded to recommend approval of The Preserve, Lot 1 Site Plan to the City Council with no conditions. The vote was: ayes – Detlefsen, Bleil, Pentecost, Heisler; nays – Staber, Gebhart. Motion carried.

North Liberty Road Street Partial ROW Vacation

Staff Presentation

Wheatley presented the request of the City of North Liberty to approve an unneeded portion of right-of-way associated with the reconstruction of North Liberty Road.

Public Comments

No public comments were offered.

Questions and Comments

The Commission discussed the application including additional necessary right of way vacations.

Recommendation to the City Council

Bleil moved, Gebhart seconded to recommend approval of the partial ROW vacation on North Liberty Road. The vote was: ayes – Heisler, Bleil, Staber, Detlefsen, Gebhart, Pentecost; nays – none. Motion approved.

Commercial Land Use Discussion

Staff Presentation

Wheatley led the discussion and possible recommendation to City Council regarding commercial land use and zoning. Staff recommendations were presented.

Discussion with Commission

The Commission discussed the proposed revisions. Staff will work through the discussion tonight and will bring back a revised plan.

Approval of Previous Minutes

Staber moved, Bleil seconded to approve the minutes of the March 5, 2019 Regular Session. The vote was all ayes. Minutes approved.

Old Business

Wheatley reported on the multiuse buildings on Kansas Avenue.

New Business

No new business was presented.

Adjournment

At 7:48 p.m., Staber moved, Gebhart seconded to adjourn. The vote was all ayes. Meeting adjourned.